City of Torrington

ENGINEERING DEPARTMENT (860) 489-2234



140 Main Street • City Hall Torrington, CT 06790-5245 Fax: (860) 489-2550

ADDENDUM No. 3

DATE ISSUED: August 1, 2019

RE: PATTERSON PARK AND FRANKLIN STREET IMPROVEMENTS

BID # PFI-027-072219RB

All bidders are hereby advised of the following amendments to the Contract Bid Documents, which are hereby made an integral part of the specifications for the subject project, prepared by The City of Torrington, to the same extent as all other documents. All work shall conform to the standards and provisions of same.

Bids submitted shall be deemed to include the Contract Document information as shown in Addendum No. 2. General bidders shall notify sub-bidders that may be affected by this addendum as applicable. Bidders shall be required to acknowledge receipt of this Addendum in the space provided on the Bid Proposal Form, Page BP-1. Failure to acknowledge this Addendum by the Bidder may result in the rejection of their bid. Bidders are directed to review changes to all portions of the work as changes to one portion may affect the work of another.

 Revised contract documents and plan sheets as provided by BL Companies (Addendum #3 - 13 pages) can be obtained via digital download from the City of Torrington website at <u>www.torringtonct.org/bids</u>

END OF ADDENDUM No. 3



ADDENDUM 3

DATE ISSUED	8/1/2019			
PROJECT NAME:	Patterson Park & Franklin Street Improvements			
CITY BID NO.	PFI-027-072219-RB	PROJECT NUMBER:	1900284	

Addendum 3 Contract Changes

The following contract documents have been revised as a result of Addendum 3:

- SPECIAL PROVISIONS INDEX
- FORM OF BID
- ITEM 1002008A LIGHT POLE AND FIXTURES (DECORATIVE) (SINGLE LUMINAIRE WITH BRACKET)
- ITEM 1002009A LIGHT POLE AND FIXTURES (DECORATIVE) (DOUBLE LUMINAIRE WITH BRACKET)
- ITEM 1002010A LIGHT POLE AND FIXTURES (DECORATIVE) (POST TOP)
- ITEM 1002110A DECORATIVE LIGHT POLE FOUNDATION

The following plan sheets have been **revised** as a result of Addendum 3:

- Plan Sheet LP-1
- Plan Sheet LP-2
- Plan Sheet LP-3
- Plan Sheet ES-1

The following has been added to the contract documents as a result of Addendum 3:

• ITEM 1008124A – 1" Polyvinyl chloride conduit in trench (site lighting/communications)

ADDENDUM #3

SPECIAL PROVISIONS

GENERAL

SECTION 1.01 DEFINITION OF TERMS AND PERMISSIBLE ABBREVIATIONS

SECTION 1.02 GENERAL REQUIREMENTS

SITE MODIFICATIONS

SECTION 9.39 SECTION 9.39 SECTION 9.42 SECTION 9.43	SWEEPING AND CLEANING UP SWEEPING FOR DUST CONTROL CALCIUM CHLORIDE FOR DUST CONTROL WATER FOR DUST CONTROL
SECTION 4.06	BITUMINOUS CONCRETE
SECTION 4.07	FIELD DENSITY TESTING CORRECTION
ITEM 0000110A ITEM 0000111A ITEM 0000112A	ADDITIONAL 2 INCH SCH 40 CONDUIT IN SAME TRENCH ADDITIONAL 3 INCH SCH 40 CONDUIT IN SAME TRENCH ADDITIONAL 4 INCH SCH 40 CONDUIT IN SAME TRENCH
ITEM 0069327A	CLEAN MASONRY (EXISTING WALL)
ITEM 0105180A	UTILITY CONFLICT RESOLUTION
ITEM 0201001A	CLEARING AND GRUBBING
ITEM 0202000A	EARTH EXCAVATION
ITEM 0202452A	TEST PIT
ITEM 0219011A	SEDIMENTATION CONTROL SYSTEM AT CATCH BASIN
ITEM 0304002A	PROCESSED AGGREGATE BASE
ITEM 0506026A ITEM 0506027A ITEM 0506028A	RETAINING WALL (C.I.P. CONCRETE SEAT WALL) – PATTERSON PARK RETAINING WALL (C.I.P. CONCRETE SEAT WALL) – LINEAR PLAZA RETAINING WALL (C.I.P. CONCRETE FLOOD WALL)
ITEM 0506703A	STONE STEPS (PATTERSON PARK)
ITEM 0506900A	CONCRETE COPINGS (CAST STONE CAP)
ITEM 0507001A	TYPE "C" CATCH BASIN (GRANITE CURB TOP)
ITEM 0507018A ITEM 0507897A	TYPE "C-L" CATCH BASIN WITH PEDESTRIAN GRATE YARD DRAIN
ITEM 0609001A	REPOINTED MASONRY

SP-1 INDEX

ITEM 0651011A 12" R.C. PIPE ITEM 0651012A 15" R.C. PIPE ITEM 0811001A CONCRETE CURBING (FLUSH) ITEM 0813041A STONE CURBING (MOUNTABLE) ITEM 0901005A **BOLLARD (FIXED - DECORATIVE)** ITEM 0901006A BOLLARD (FIXED - STANDARD) ITEM 0901007A **BOLLARD (REMOVABLE)** ITEM 0904040A ANODIZED METAL BRIDGE RAIL ITEM 0909501A TIMBER RAIL FENCE ITEM 0914030A DECORATIVE ALUMINUM FENCE ITEM 0914031A DECORATIVE ALUMINUM GATE ITEM 0921001A CONCRETE SIDEWALK ITEM 0921002A CONCRETE SIDEWALK – 8" THICK (HEAVY DUTY SIDEWALK) ITEM 0921003A CONCRETE SIDEWALK (COLORED CONCRETE) ITEM 0921008A BRICK PAVERS ON CONCRETE ITEM 0921009A **BRICK AMENITY STRIP** ITEM 0921024A CONCRETE PAVERS (LABYRINTH) ITEM 0949020A DAFFODIL ITEM 0949021A **DWARF PRAIRIE DROPSEED** ITEM 0949022A NORTHWIND SWITCHGRASS ITEM 0949063A **DWARF FOUNTAIN GRASS DWARF FOTHERGILLA** ITEM 0949298A ITEM 0949345A LILY TURF

ITEM 0949565A FEATHER REED GRASS

ITEM 0949757A AUTUMN BRILLIANCE SERVICEBERRY

ITEM 0949763A DWARF OAKLEAF HYDRANGEA

ITEM 0949838A RED SUNSET RED MAPLE
ITEM 0949897A SHAMROCK INKBERRY
ITEM 0949913A CITY SLICKER RIVER BIRCH
ITEM 0949962A EXCLAMATION PLANETREE

ITEM 0970006A UNIFORMED MUNICIPAL POLICE OFFICER
ITEM 0970007A TRAFFIC PERSON (UNIFORMED FLAGGER)
ITEM 0971001A MAINTENANCE AND PROTECTION OF TRAFFIC

ITEM 0975004A MOBILIZATION AND PROJECT CLOSEOUT

ITEM 0980001A CONSTRUCTION STAKING

ITEM 0992090A BENCH – CIRCULAR (WOOD SEATING MOUNTED TO CONCRETE SEAT

WALLS)

ITEM 0992091A BENCH – STRAIGHT (WOOD SEATING MOUNTED TO CONCRETE SEAT

WALLS)

ITEM 0992103A TRASH RECEPTACLE

SP-2 INDEX

ITEM 1002008A	LIGHT POLE AND FIXTURES (DECORATIVE) (SINGLE LUMINAIRE WITH BRACKET)
ITEM 1002009A	LIGHT POLE AND FIXTURES (DECORATIVE) (DOUBLE LUMINAIRE WITH
ITEM 1002010A	BRACKET) LIGHT POLE AND FIXTURES (DECORATIVE) (POST TOP)
ITEM 1002011A	CATENARY LIGHT POLE
ITEM 1002012A	CATENARY LIGHTING
ITEM 1002110A	DECORATIVE LIGHT POLE FOUNDATION
ITEM 1008124A	1" POLYVINYL CHLORIDE CONDUIT IN TRENCH (SITE
	LIGHTING/COMMUNICATIONS)
ITEM 1017054A	RE-FEED OF ELECTRICAL SERVICES TO 37 VOLKMAN LANE
ITEM 1017055A	RE-FEED OF ELECTRICAL SERVICES TO 33 FRANKLIN LANE
ITEM 1017056A	NEW FEED FOR METER PEDESTAL
ITEM 1017066A	ELECTRICAL TRANSFORMER CONCRETE PAD, HANDHOLE AND SILO
ITEM 1113011A	3 CONDUCTOR NO. 12 AWG, THWN
ITEM 1113012A	3 CONDUCTOR NO. 10 AWG, THWN
ITEM 1113013A	3 CONDUCTOR NO. 8 AWG, THWN
ITEM 1113014A	3 CONDUCTOR NO. 6 AWG, THWN
ITEM 1118012A	REMOVAL AND RELOCATION OF TRAFFIC SIGNAL EQUIPMENT
ITEM 1206023A	REMOVAL AND RELOCATION OF EXISTING SIGNS
ITEM 1210105A	GREENWAY TRAIL SURFACE TREATMENT COLOR
ITEM 1403501A	RESET MANHOLE (SANITARY SEWER)

SUPPLEMENTAL TECHNICAL SPECIFICATIONS

040140	MAINTENANCE OF STONE ASSEMBLIES
042000	UNIT MASONRY
047200	CAST STONE
079005	JOINT SEALERS

SP-3 INDEX

Patterson Park & Franklin Street Improvements

City Bid No. PFI-027-072219-RB

Addendum #3 - 08/01/2019

:	TRENCHING AND BACKFILLING (ELECTRIC, CABLE, PHONE)	750 L.F.		Dollars	\$ 	\$
	,		and	Cents		
1002008A	LIGHT POLE AND FIXTURES (DECORATIVE)	2 EA.		Dollars	\$ <u>-</u>	\$ <u>-</u>
	(SINGLE LUMINAIRE WITH BRACKET)		and	Cents		
1002009A	LIGHT POLE AND FIXTURES (DECORATIVE)	10 EA.		Dollars	\$ <u>=</u>	\$ <u>-</u>
	(DOUBLE LUMINAIRE WITH BRACKET)		and	Cents		
1002010A	LIGHT POLE AND FIXTURES (DECORATIVE)	8 EA.		Dollars	\$ 	\$
(POST TOP)			and	Cents		
1002011A	CATENARY LIGHT POLE	LIGHT POLE 9 EA		Dollars	\$ <u>=</u>	\$
			and	Cents		
1002012A	CATENARY LIGHTING	750 LF		Dollars	\$ 	\$ <u>-</u>
			and	Cents		
1002110A DECORATIVE LIGHT POLE FOUNDATION	· · · · · · · · · · · · · · · · · · ·	29 EA.		Dollars	\$ <u>=</u>	\$ <u>-</u>
	TOUNDATION		and	Cents		
1002203	TRAFFIC CONTROL FOUNDATION – PEDESTAL-TYPE I	1 EA.		Dollars	\$ <u>-</u>	\$ <u>-</u>
(TRAFFIC)	i i		and	Cents		
1003924		2 EA.		Dollars	\$ 	\$ <u>-</u>
\sim	CONCRETE BASE		and	Cents		
1008124A	" POLYVINYL CHLORIDE CONDUIT IN TRENCH	N 1500 L.F.		Dollars	\$ 	\$ <u>-</u>
(SITE LIGHTING/COMMUNICATIONS)			and	Cents		

ITEM # 1002008A – LIGHT POLE AND FIXTURES (DECORATIVE) (SINGLE LUMINAIRE WITH BRACKET)

ITEM # 1002009A – LIGHT POLE AND FIXTURES (DECORATIVE) (DOUBLE LUMINAIRE WITH BRACKET)

<u>ITEM # 1002010A – LIGHT POLE AND FIXTURES (DECORATIVE) (POST TOP)</u> ITEM # 1002110A - DECORATIVE LIGHT POLE FOUNDATION

- **9.92.01 Description:** Under this item the contractor shall provide and install all decorative light bases and decorative street lights as shown on the plans and specified herein.
- **9.92.02 Materials:** The materials for the work shall conform to the following:
- **1. Decorative Street Lights:** Contractor responsible for providing and installation of the following poles and lamps:

MANUFACTURER: LUMEC (SIGNIFY)

LUMINAIRE:

FIXTURE: SERENADE DSX S55

BRACKET: LUMEC – CRA-2F-180DEG-BKTX

POLE:

1. POST TOP: RAF805-13-ARRA-BA-GFII-PS-3/4X20-12 ½-DEC-BKTX-LMS52324A

2. BRACKET ARMS: RA805R-18-CAP1-GFII-MPL-PSS16-12.5-BKTX

3. BRACKET: CRA-2F-180DEG-BKTX

4. BANNER ARM: BAD – DOUBLE ARM (24" LENGTH)

MOUNT: REFER TO LIGHTING PLANS

The contractor responsible for installation of pre-cast concrete bases, trenching and laying of conduit with sweeps in and out of base, a driven ground rod with bare copper wire at each base, and installation of the pole and lamps and receptacle. Coordinate with Eversource for their portion of work. The contractor is responsible for providing and installing wire from the power pedestal to each pole with lamp and receptacle.

2. Decorative Light Base: The contractor is responsible for installation of pre-cast concrete bases, trenching and laying of conduit with sweeps in and out of base, conduit within foundation and reducers, a driven ground rod with bare copper wire at each base, and installation of each pole with lamp and receptacle.

3. Concrete foundations: Class "F" concrete shall conform to the requirements of section 6.01 and Article M.03.01 of the State of Connecticut Department of Transportation Standard Specifications for Roads, Bridges and Incidental Construction Form 817.

The reinforcing steel shall conform to Article M.06.01 of the State of Connecticut Department of Transportation Standard Specifications for Roads, Bridges and Incidental Construction Form 817.

9.92.03 – Construction Methods:

The decorative street lights shall be installed in accordance with the manufacturer's recommendations and anchor bolted to a concrete base at the location and in the method as shown on the plans or as directed by the Engineer.

The concrete foundations for the decorative lights shall be set on flat compacted subgrade. It shall be backfilled in compacted 6" lifts up to the depth as specified in the construction documents.

Contractor shall install decorative light bases in accordance with the methods of construction as shown on the plans or as directed by the Engineer.

9.92.04 – Method of Measurement:

The work shall be measured for payment by the actual number of each decorative street light and decorative light base complete and accepted in place.

There will be no measurement of payment for the cost of conduit within foundation and reducers, brackets, banner arms, GFI receptacles, timer with photocell, subbase preparation, concrete, reinforcement, coordination, or trenching and backfilling.

9.92.05 – **Basis of Payment:**

This work will be paid for at the contract unit price per each (ea.) light pole and fixtures (decorative) and decorative light pole foundation complete and accepted in place, which price shall include all coordination, materials, excavation, reinforcement, concrete, subbase preparation, equipment, tools and labor incidental thereto the placement of each item.

Light pole, bracket, banner arms, receptacles and timer with photocell shall be included in Contract unit price for "Light Pole and Fixtures (Decorative)."

<u>Pay Item</u>	Pay Unit
Light Pole and Fixtures (Decorative) (Single Luminaire with Bracket)	ea.
Light Pole and Fixtures (Decorative) (Double Luminaire with Bracket)	ea.
Light Pole and Fixtures (Decorative) (Post Top)	ea.
Decorative Light Pole Foundation	ea.

9.92.06 - Notice to Contractor:

The quantities for all light pole items may decrease should the city decide to change the design pattern.

Architecture Engineering Environmental Land Surveying



355 Research Parkway Meriden, CT 06450 (203) 630-1406 (203) 630-2615 Fax

EMEN

ANKLIN STREET IMPRO ANKLIN STREET DRRINGTON, CT

ATTERSON PARK & FR

Desc.
REVISIONS PER CITY COMMENTS
ISSUED FOR BID
ISSUED FOR BID
ADDENDUM #2

REVISIONS

No. Date
Dos

1. 04/29/2019 REV
2. 05/01/2019 ISSI
3. 06/27/2019 ISSI
4. 07/24/2019 AD

Designed W.E.V.
Drawn W.E.V.
Reviewed
Scale 1"=20'
Project No. 1900284
Date 04/19/2019

Project No.

Date 04

CAD File:
LP190028401

Title


LIGHTING PLAN

Sheet No.

WETHERSFIELD, CT 06109

LP-1

* LLF Determined Using Current Published Lamp Data

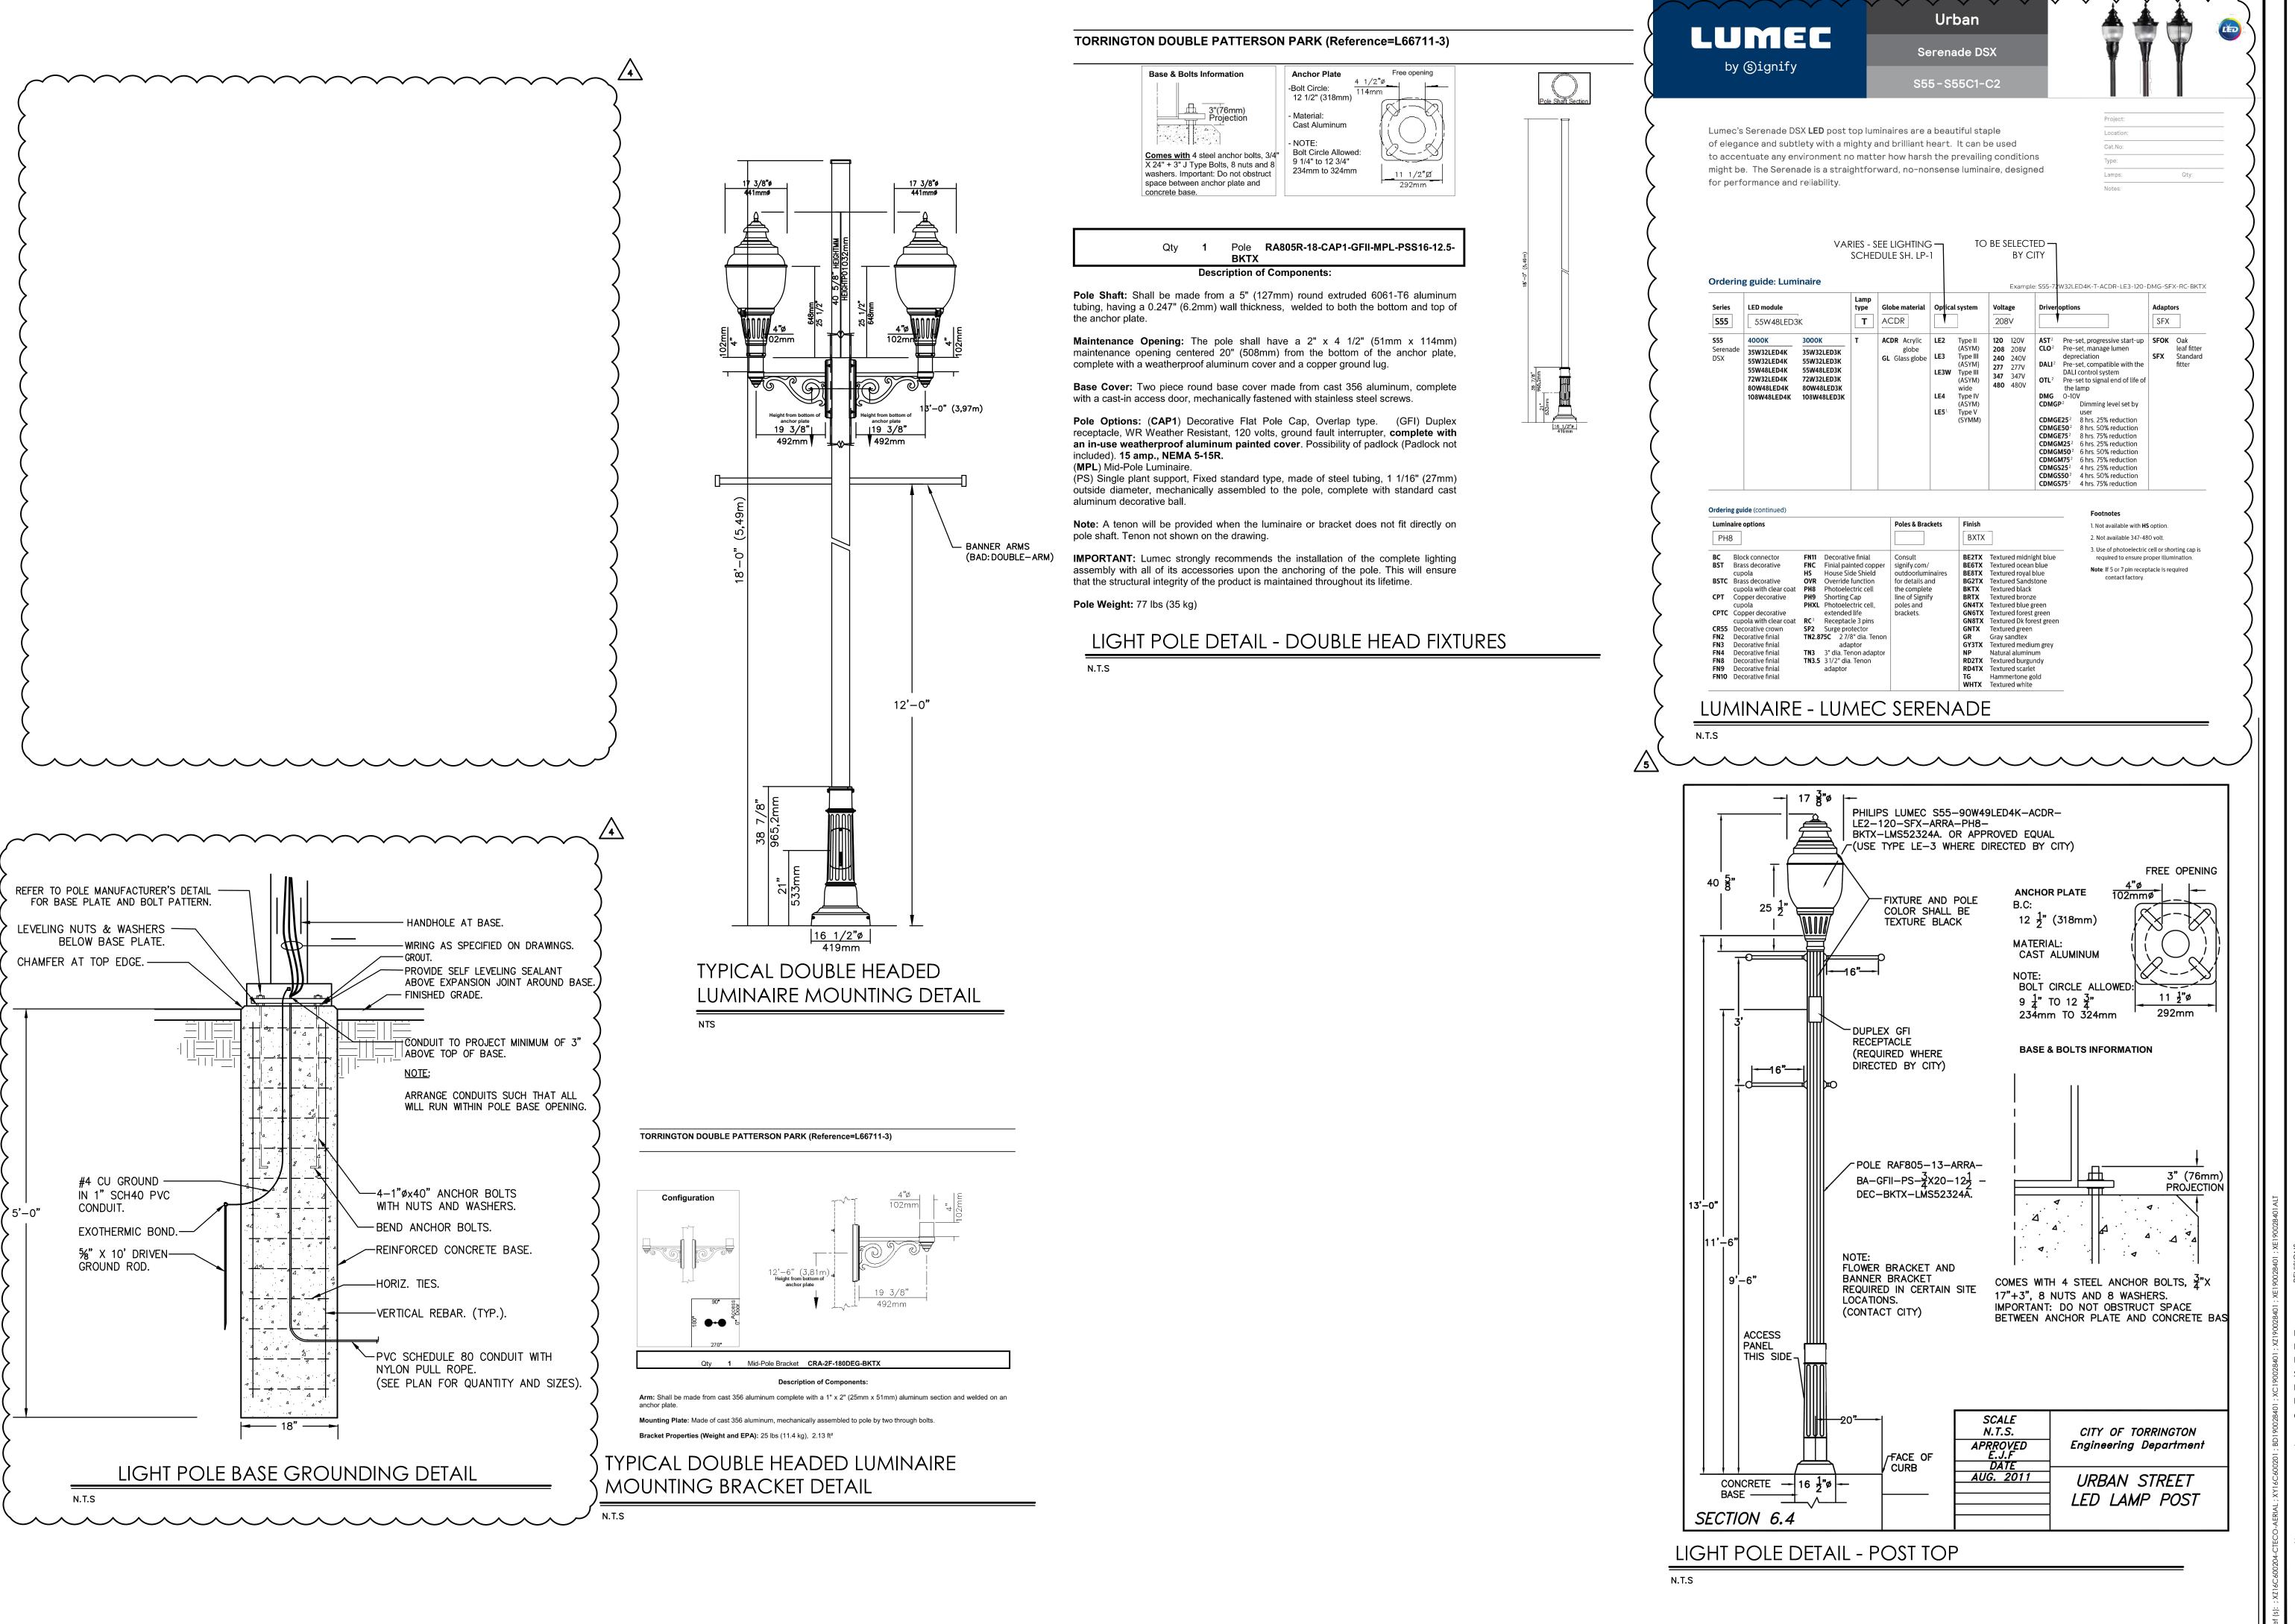

DI 9 BL COMPANIES, INC. THESE DRAWINGS SHALL NOT BE UTILIZED BY ANY PERSON, FIRM OR CORPORATION WITHOUT THE SPECIFIC WRITTEN PERMISSION OF BL COMPANIES

355 Research Parkway Meriden, CT 06450 (203) 630-1406

(203) 630-2615 Fax

VEMEN 0 IMPR ᆸ Ш

STR ANKLIN ANKLIN ORRINGTO

Z 0

ATTERS

Ž - 7 ε 4 ε

W.E.V.

W.E.V.

NONE


1900284


04/19/2019


CAD File:

LP190028401

LIGHTING **DETAILS**

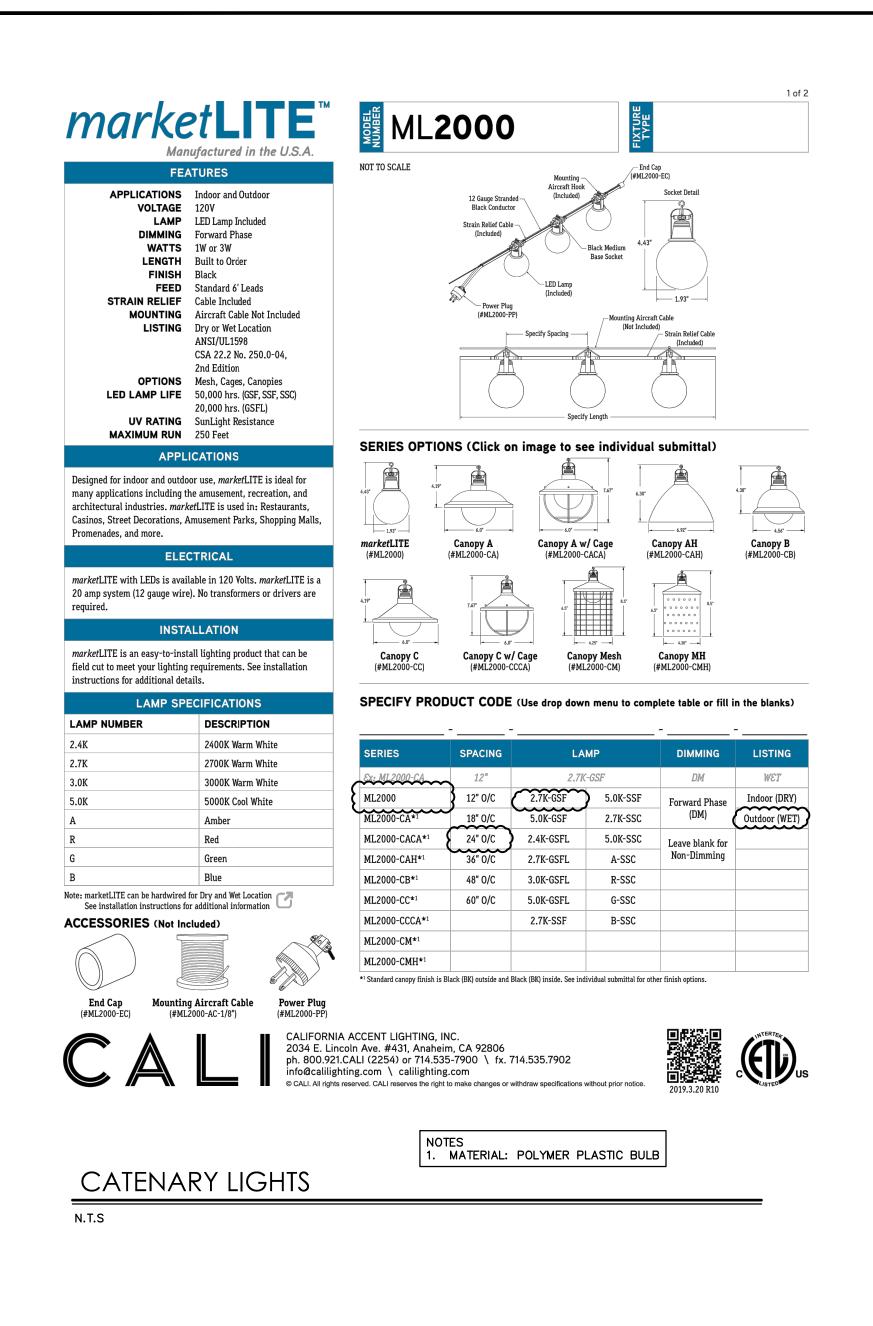

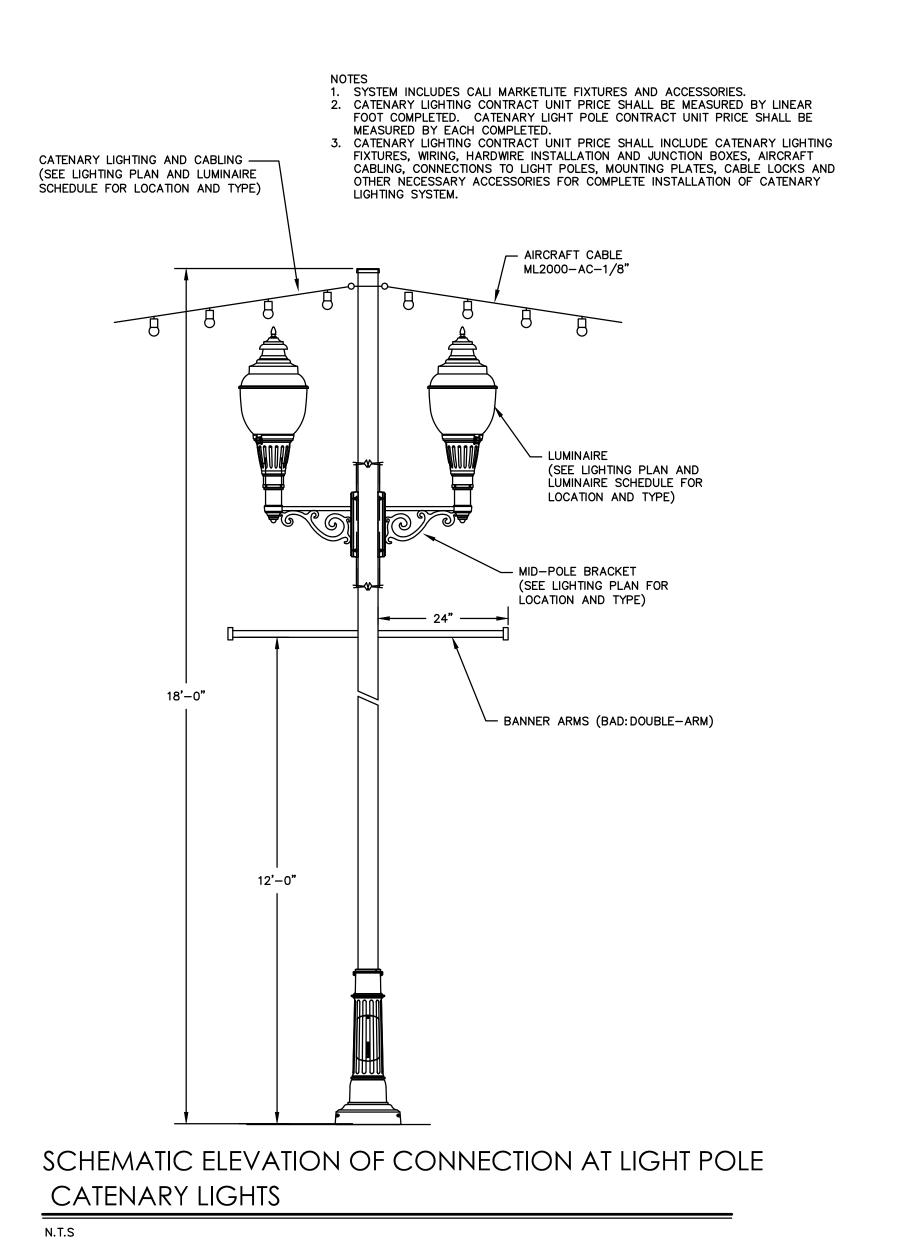

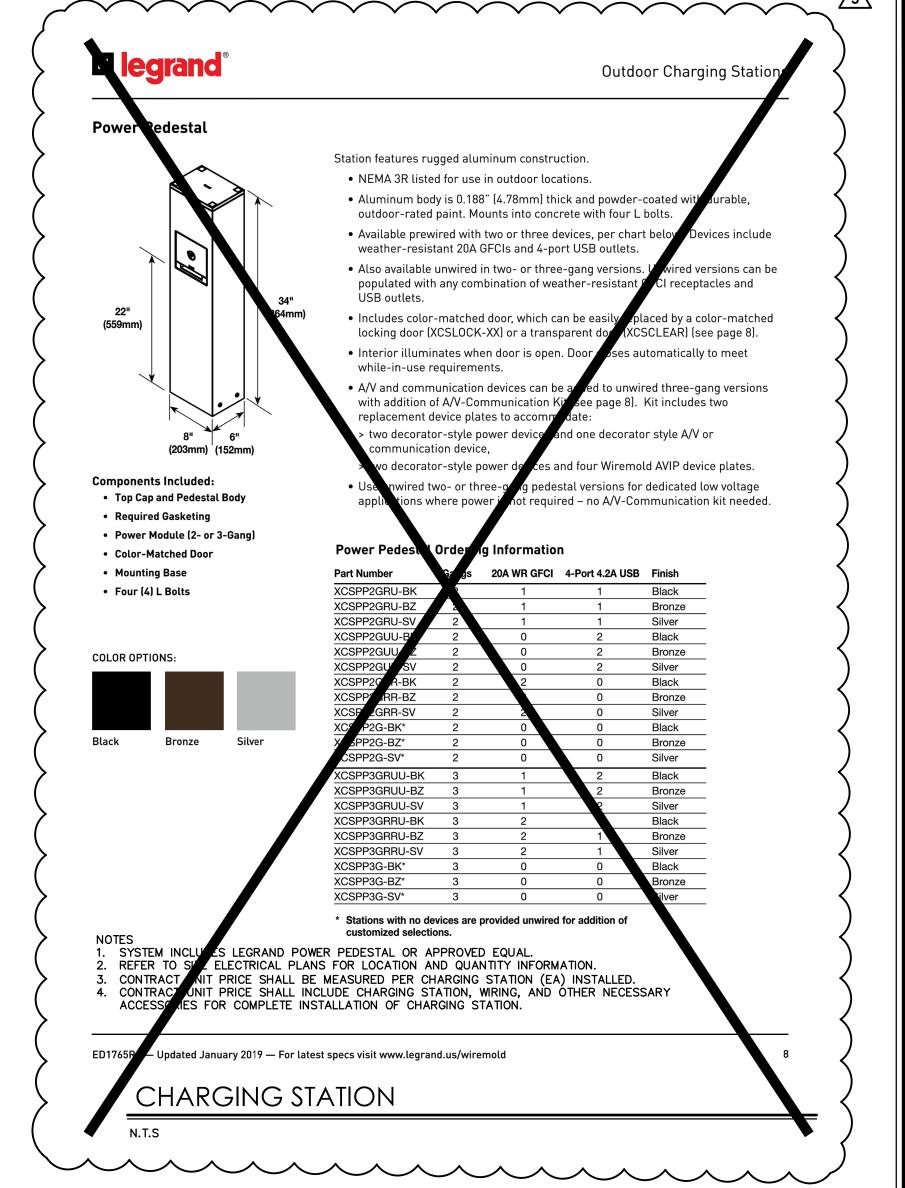

355 Research Parkway Meriden, CT 06450 (203) 630-1406 (203) 630-2615 Fax VEMEN IMPR ᆸ Ш STRI ANKLIN ANKLIN ORRINGTO **ATTERSON**

LP-3

© 2019 BL COMPANIES, INC. THESE DRAWINGS SHALL NOT BE UTILIZED BY ANY PERSON, FIRM OR CORPORATION WITHOUT THE SPECIFIC WRITTEN PERMISSION OF BL COMPANIES

1900284

LP190028401

LIGHTING DETAILS

Architecture

Architecture

British Architecture

Architecture

Engineering

Environmental

(203) 630-1406
(203) 630-2615 Fax

EET IMPROVEMENTS

FRANKLIN ST FRANKLIN STREET TORRINGTON, C

Desc.
9/2019 REVISIONS PER CITY COMMENTS
1/2019 ISSUED FOR BID
7/2019 ISSUED FOR BID
4/2019 ADDENDUM #2
1/2019 ADDENDUM #3

TTER

Designed W.E.V.

Drawn W.E.V.

Reviewed

Scale 1"=20'

Project No. 1900284

Date 04/19/2019

CAD File:

Title

ELECTRICAL

SITE PLAN

ES190028401

Sheet No.

SCALE IN FEET

ES-1

ITEM #1008124A 1" POLYVINYL CHLORIDE CONDUIT IN TRENCH (SITE LIGHTING/COMMUNICATIONS)

1" Polyvinyl chloride conduit in trench (site lighting/communications) shall be constructed in accordance with Section 10.08, supplemented as follows:

Description: This item shall consist of furnishing and installing conduit of the size and type specified with necessary fittings, where called for, at locations shown on the plans or as directed by the Engineer and in accordance with these specifications.

Weatherproof GFI receptacles for Charging Stations as indicated on the plans shall be paid for under this item.

Method of Measurement: Conduit will be measured for payment by the actual number of linear feet of the type and size installed and accepted. The measured length shall be from end to end along the centerline through all fittings.

No additional measurement will be made for Weatherproof GFI receptacles for Charging Stations.

Basis of Payment: The work will be paid for at the Contract unit price per linear foot for "1" Polyvinyl chloride conduit." The price shall include all materials required expansion fittings, conduit fittings, locknuts, bonding bushings, bonding wire, hangers, clamps, duct seal, caps, inserts, equipment, tools, labor, and work incidental thereto.

Contract unit price for "1" Polyvinyl chloride conduit" includes Weatherproof GFI receptacles for Charging Stations.

Pay Item Pay Unit

1" POLYVINYL CHLORIDE CONDUIT IN TRENCH
(SITE LIGHTING/COMMUNICATIONS)

L.F.