


T.C. MAP #3928

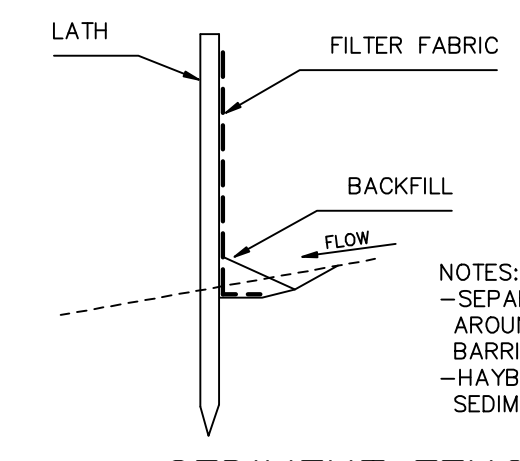


**SEDIMENT FENCE DETAIL**

NOTES:  
 - SEPARATE SECTIONS OF FENCE TO BE WRAPPED AROUND BOTH END POLES TO MAKE A CONTINUOUS BARRIER.  
 - HAYBALES MAY BE SUBSTITUTED OR USED WITH SEDIMENT FENCE AS DIRECTED BY TOWN OR ENGINEER.

**EROSION AND SEDIMENTATION CONTROL NOTES :**  
 - EROSION AND SEDIMENTATION CONTROL MEASURES TO BE INSTALLED AT THE TOE OF SLOPES OR AS SHOWN ON THE PLANS.  
 - ALL MEASURES TO BE INSTALLED PRIOR TO GROUND DISTURBANCE.  
 - TOPSOIL TO BE STRIPPED, STOCKPILED AND SEEDED IN ALL AREAS OF PROPOSED GRADING.  
 - EROSION CONTROL MEASURES TO BE MAINTAINED THROUGHOUT THE CONSTRUCTION PROCESS UNTIL DISTURBED AREAS ARE STABILIZED. ADDITIONAL CONTROL MEASURES MAY BE NECESSARY.  
 - THE OWNER OF RECORD / CONTRACTOR SHALL BE RESPONSIBLE FOR THE INSTALLATION AND MAINTENANCE OF EROSION CONTROLS.  
 - ALL EROSION AND SEDIMENTATION CONTROLS TO BE INSTALLED IN ACCORDANCE WITH THE 2002 CT GUIDELINES FOR SOIL EROSION AND SEDIMENT CONTROL.

**LEGEND**

APPROX. PROPERTY LINE	—————
BLDG. SETBACK LINE	—————
EASEMENT LINE	-----
UTILITY POLE	⊕
STONE WALL	⊖⊖⊖⊖⊖⊖⊖⊖
WATERCOURSE	~~~~~
FLAGGED WETLANDS	----- 5 -----
EXISTING CONTOUR	990 ~~~~~
PROPOSED CONTOUR	990 ———
EXISTING SPOT ELEVATION	991.5
PROPOSED SPOT ELEVATION	991+5
SEDIMENT FENCE	▬▬▬▬▬▬▬▬▬▬

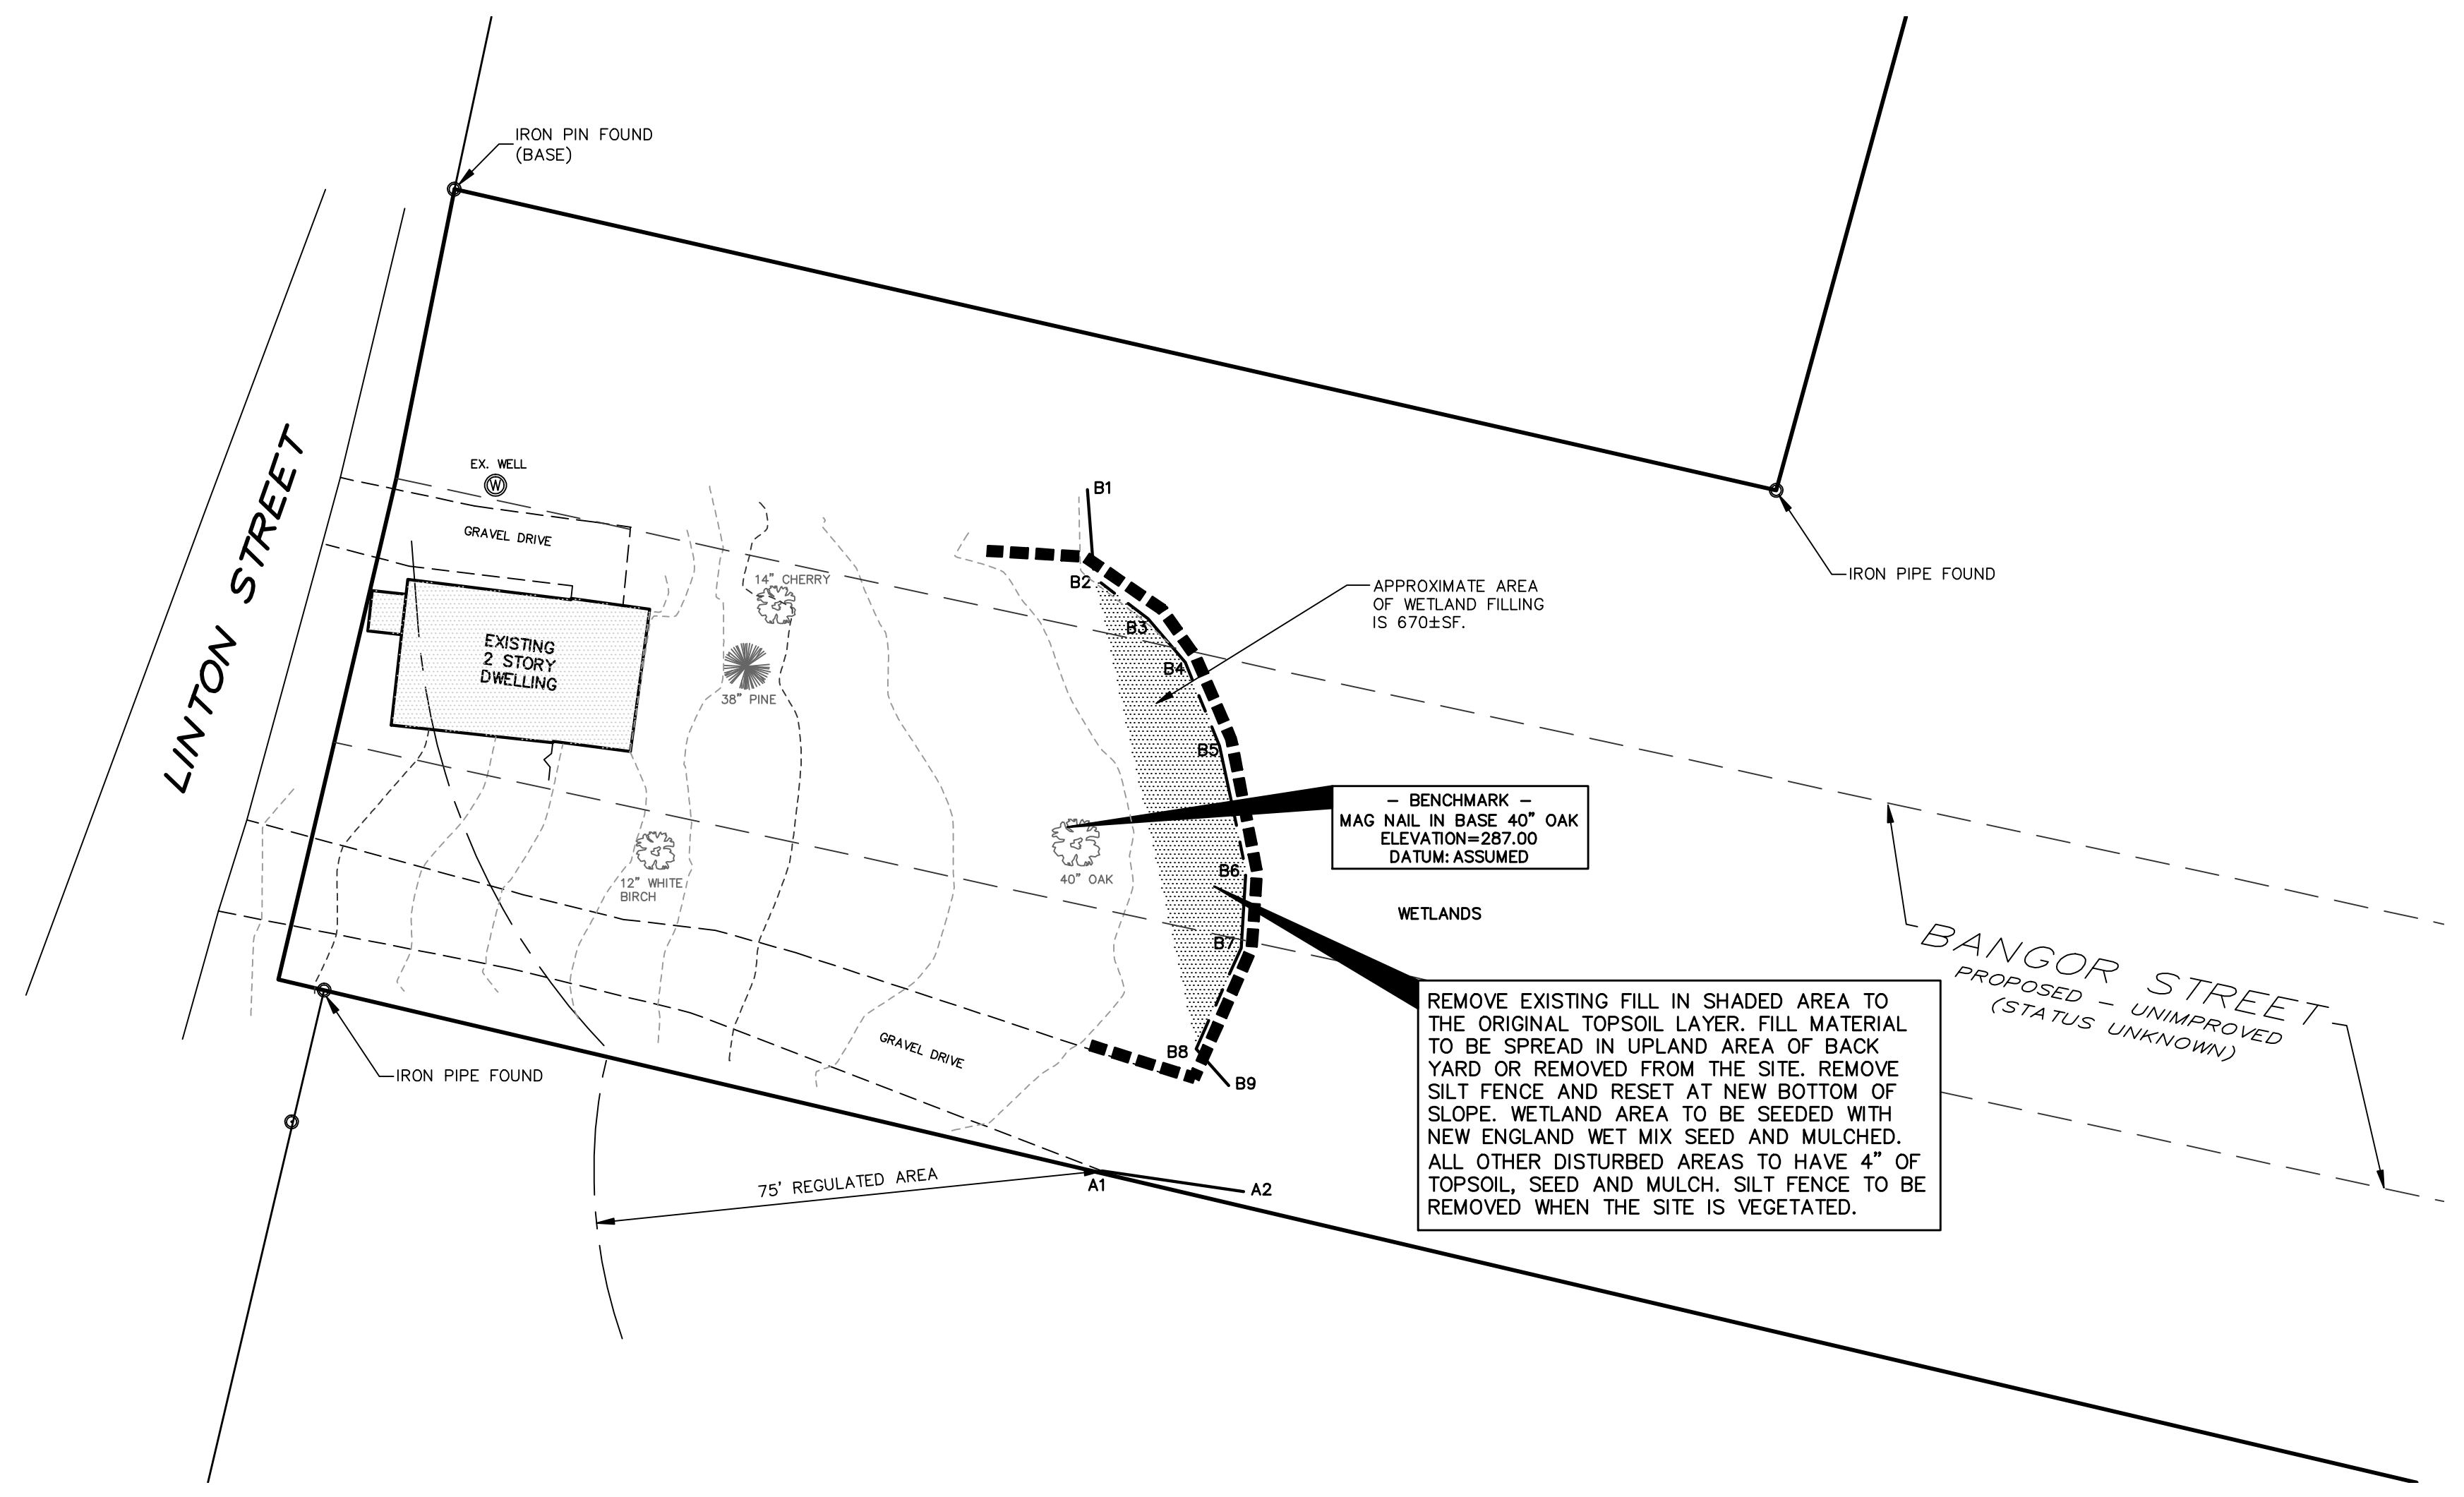

NOTES:  
 - BOUNDARY INFORMATION BASED ON TOWN CLERK MAPS #2666, #3926 AND MAP #P.484-B LOCATED WITH THE CITY ENGINEERING DEPARTMENT. PROPERTY LINES ARE APPROXIMATE. NO A-2 SURVEY HAS BEEN PERFORMED BY THIS OFFICE.  
 - TOPOGRAPHIC INFORMATION BASED ON FIELD SURVEY BY THIS OFFICE. VERTICAL DATUM IS ASSUMED.  
 - WETLANDS WERE IDENTIFIED IN FIELD BY GEORGE MALIA, SOIL SCIENTIST AND LOCATED BY THIS OFFICE.  
 - LOT AREA: 33.5 ± ACRES

**SITE RESTORATION PLAN**  
 PREPARED FOR  
**STEPHEN GIROLIMON**  
 194 LINTON STREET  
 TORRINGTON, CONNECTICUT

**BERKSHIRE ENGINEERING & SURVEYING, LLC**

143 BANTAM LAKE ROAD  
 BANTAM, CONNECTICUT 06750 (860)567-8007  
 (860)567-8006 (fax)

Date: 07/02/21	Proj. No.: 20-3368(1)	Sheet: 1/1
Scale: 1"=20'	Drawn By: MS/DSM	Map No.: 3368

*[Signature]*  
 Not valid without original seal