

BASE PLAN REFERENCE: Property Lines, Topography, and Existing Features shown are from an A-2 Original Survey and a Class D Compilation Plan prepared by Keele Land Surveying, 492 Main Street, Winstead, CT



NANCY B. JACKSON, PE L.C. NO. 17205


REVISIONS:

- APRIL 29, 2022: Revised Proposed Sedimentation and Erosion Control Measures per City Engineer's comments.


CAD: JE 22-03.DWG
DATE: 03/15/2022
PROJ. NO.: JE 22-03
CHECKED: NBJ
DRAWN: JSJ
SCALE: 1"=20'

SITE PLAN


SP-2

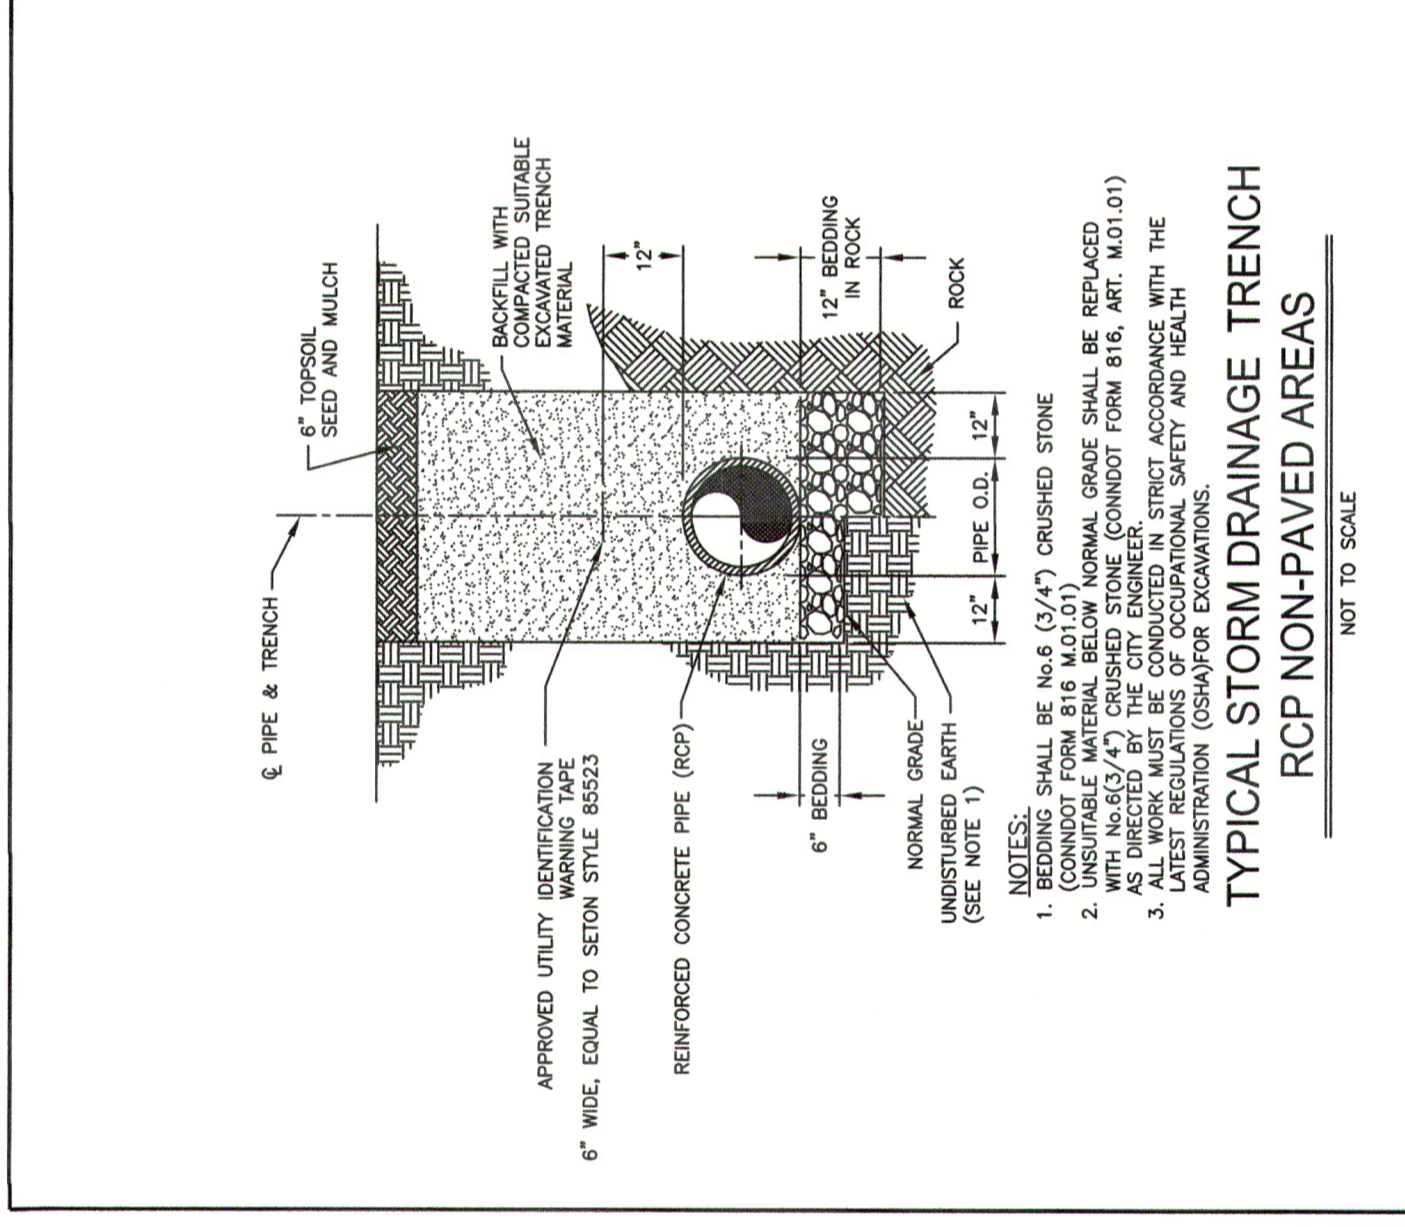


SCALE	CITY OF TORRINGTON
APPROVED	Engineering Department
DATE	TYPICAL STORM DRAINAGE TRENCH RCP NON-PAVED AREAS
REVISION	

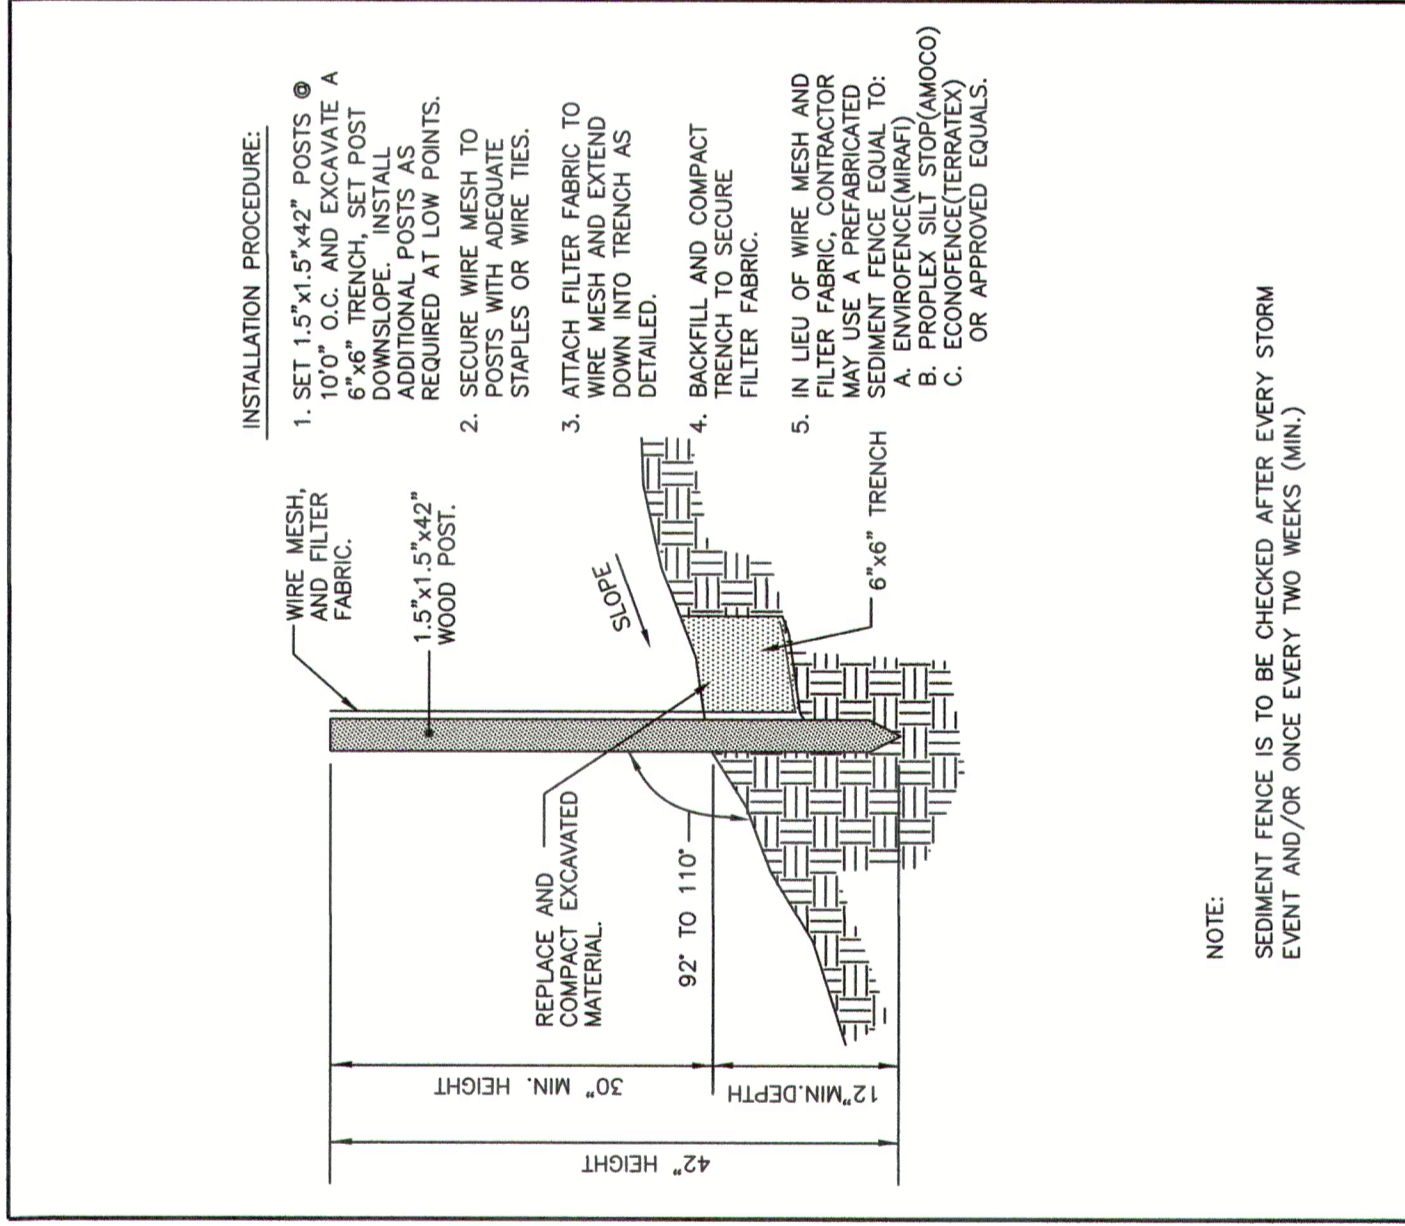


SCALE	CITY OF TORRINGTON
APPROVED	Engineering Department
DATE	CONSTRUCTION SILT FENCE
REVISION	

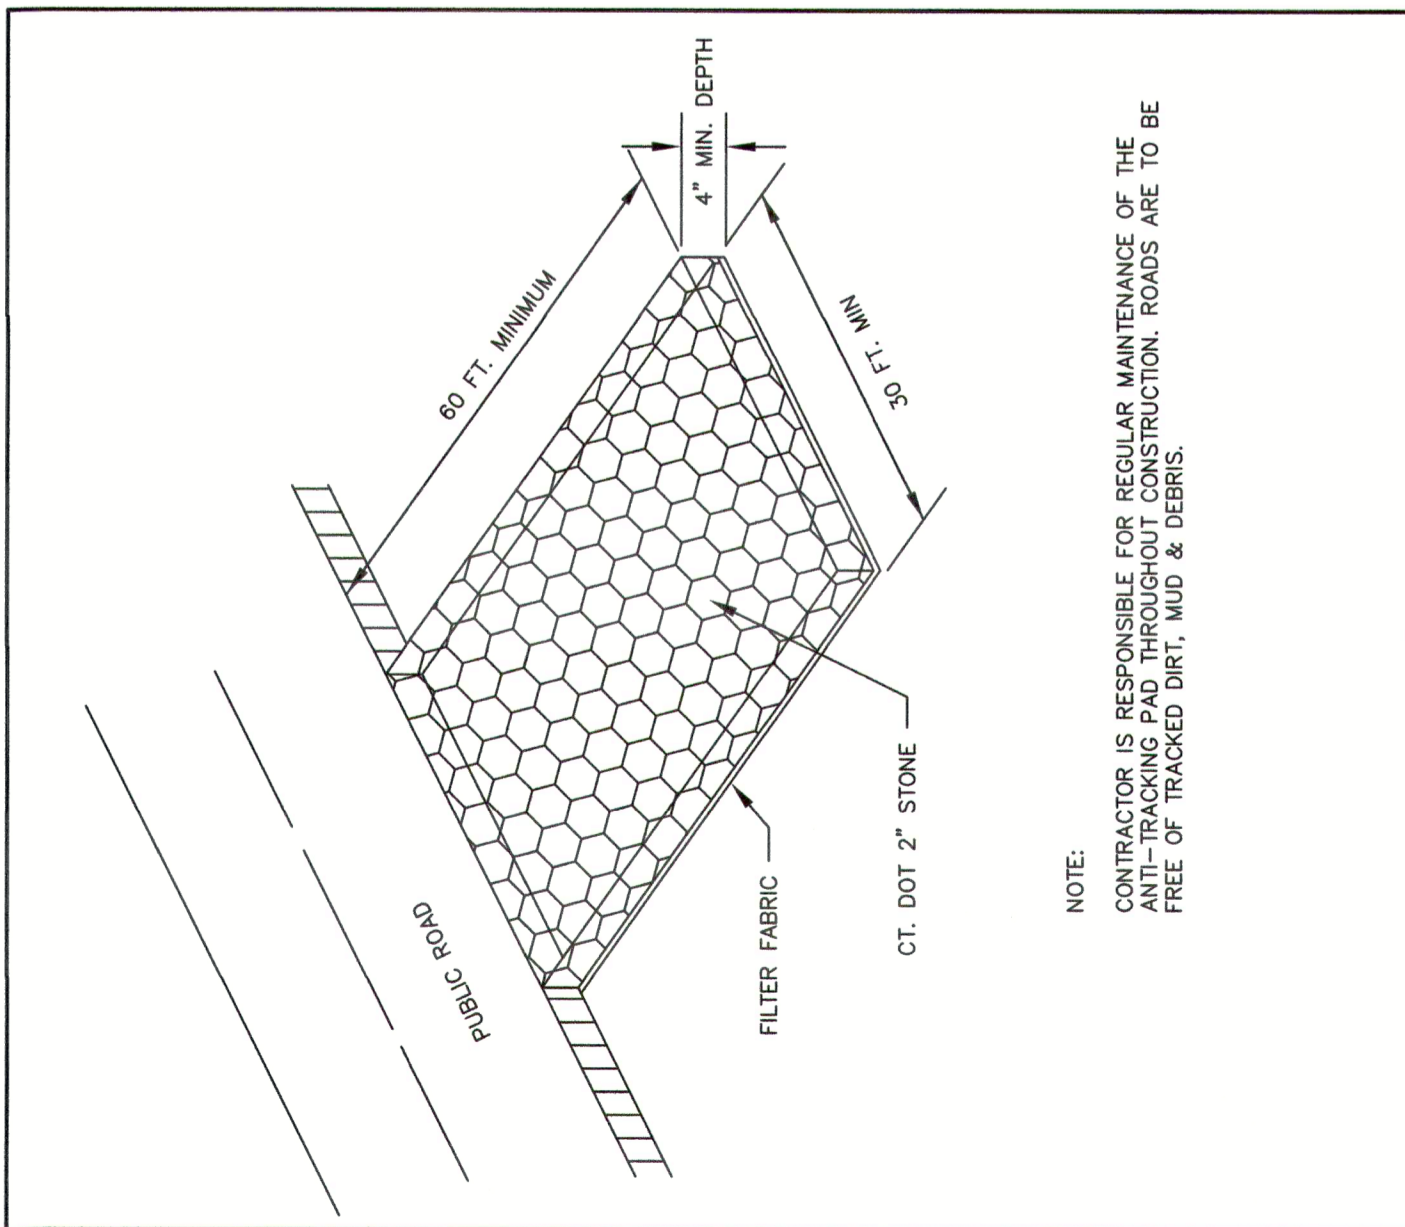


SCALE	CITY OF TORRINGTON
APPROVED	Engineering Department
DATE	TYPICAL CONSTRUCTION ENTRANCE & EXIT
REVISION	

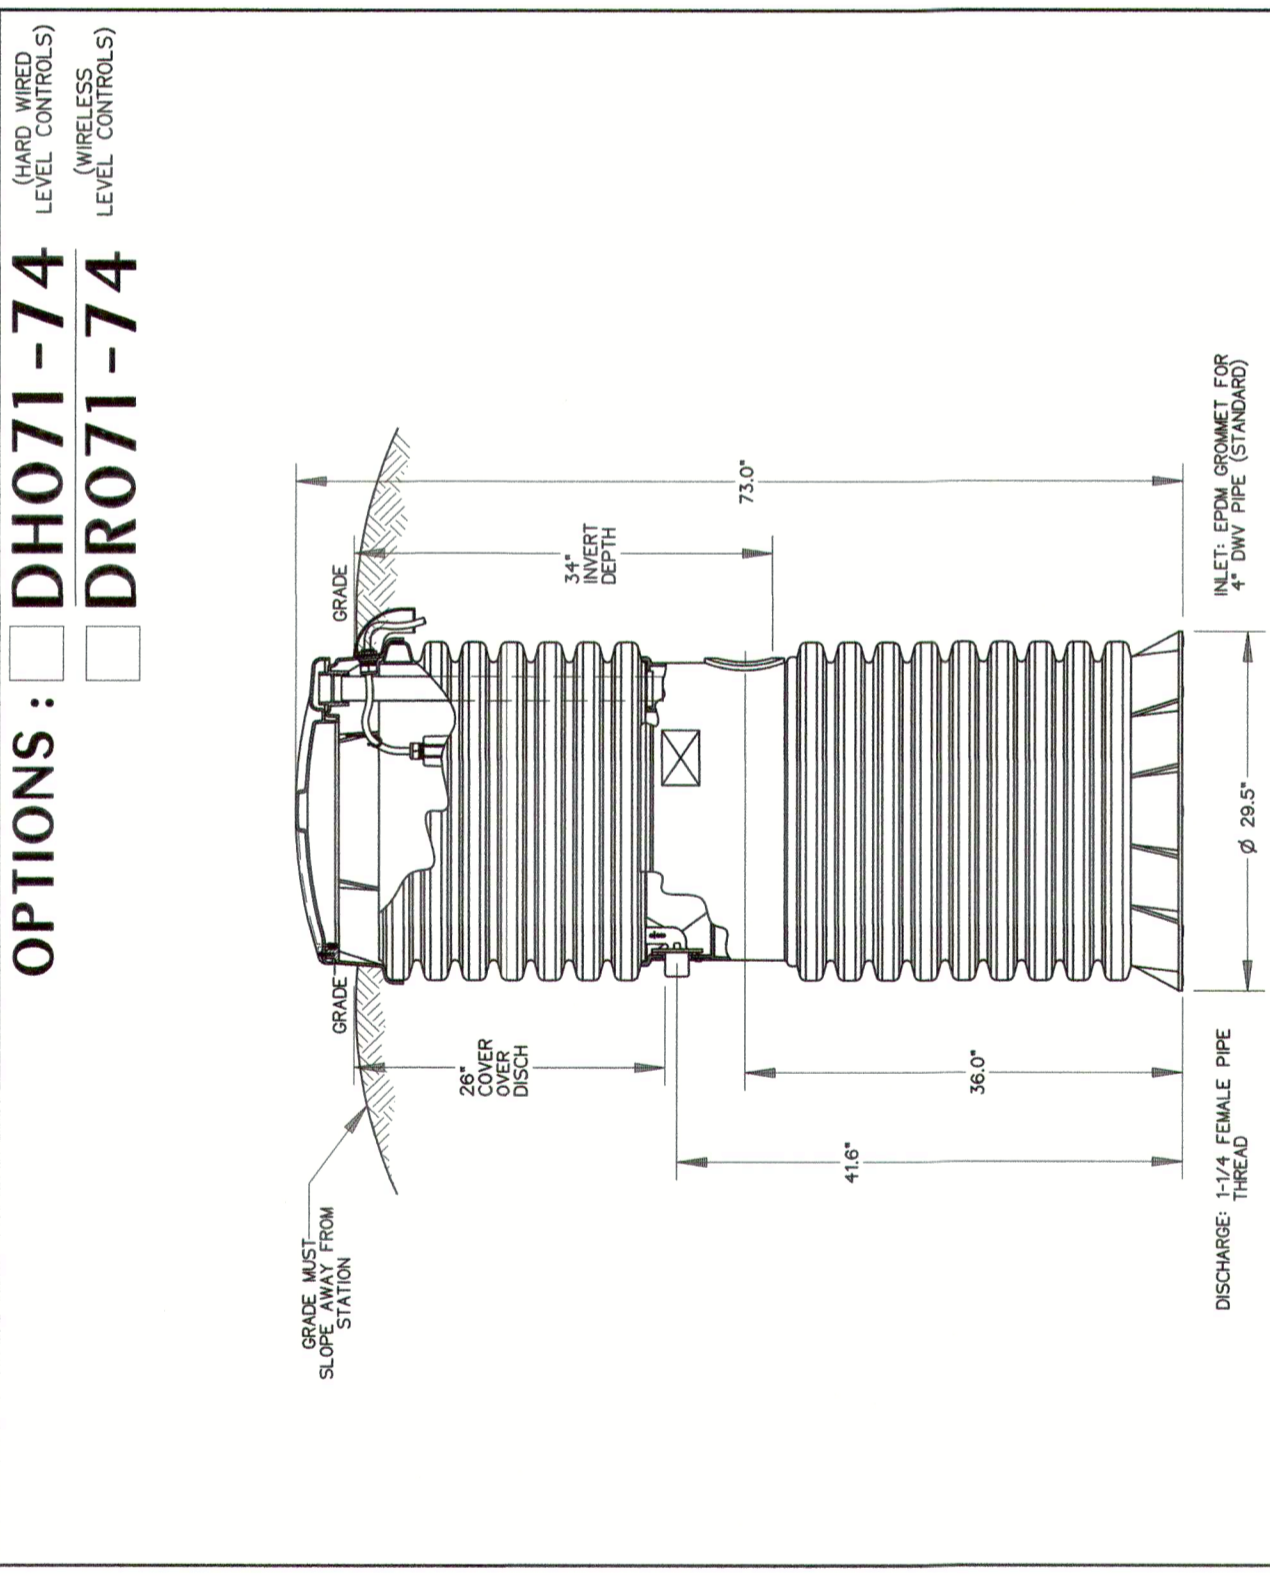

SCALE	CITY OF TORRINGTON
APPROVED	Engineering Department
DATE	STAINLESS STEEL LATERAL KIT 1-1/4\"/>
REVISION	

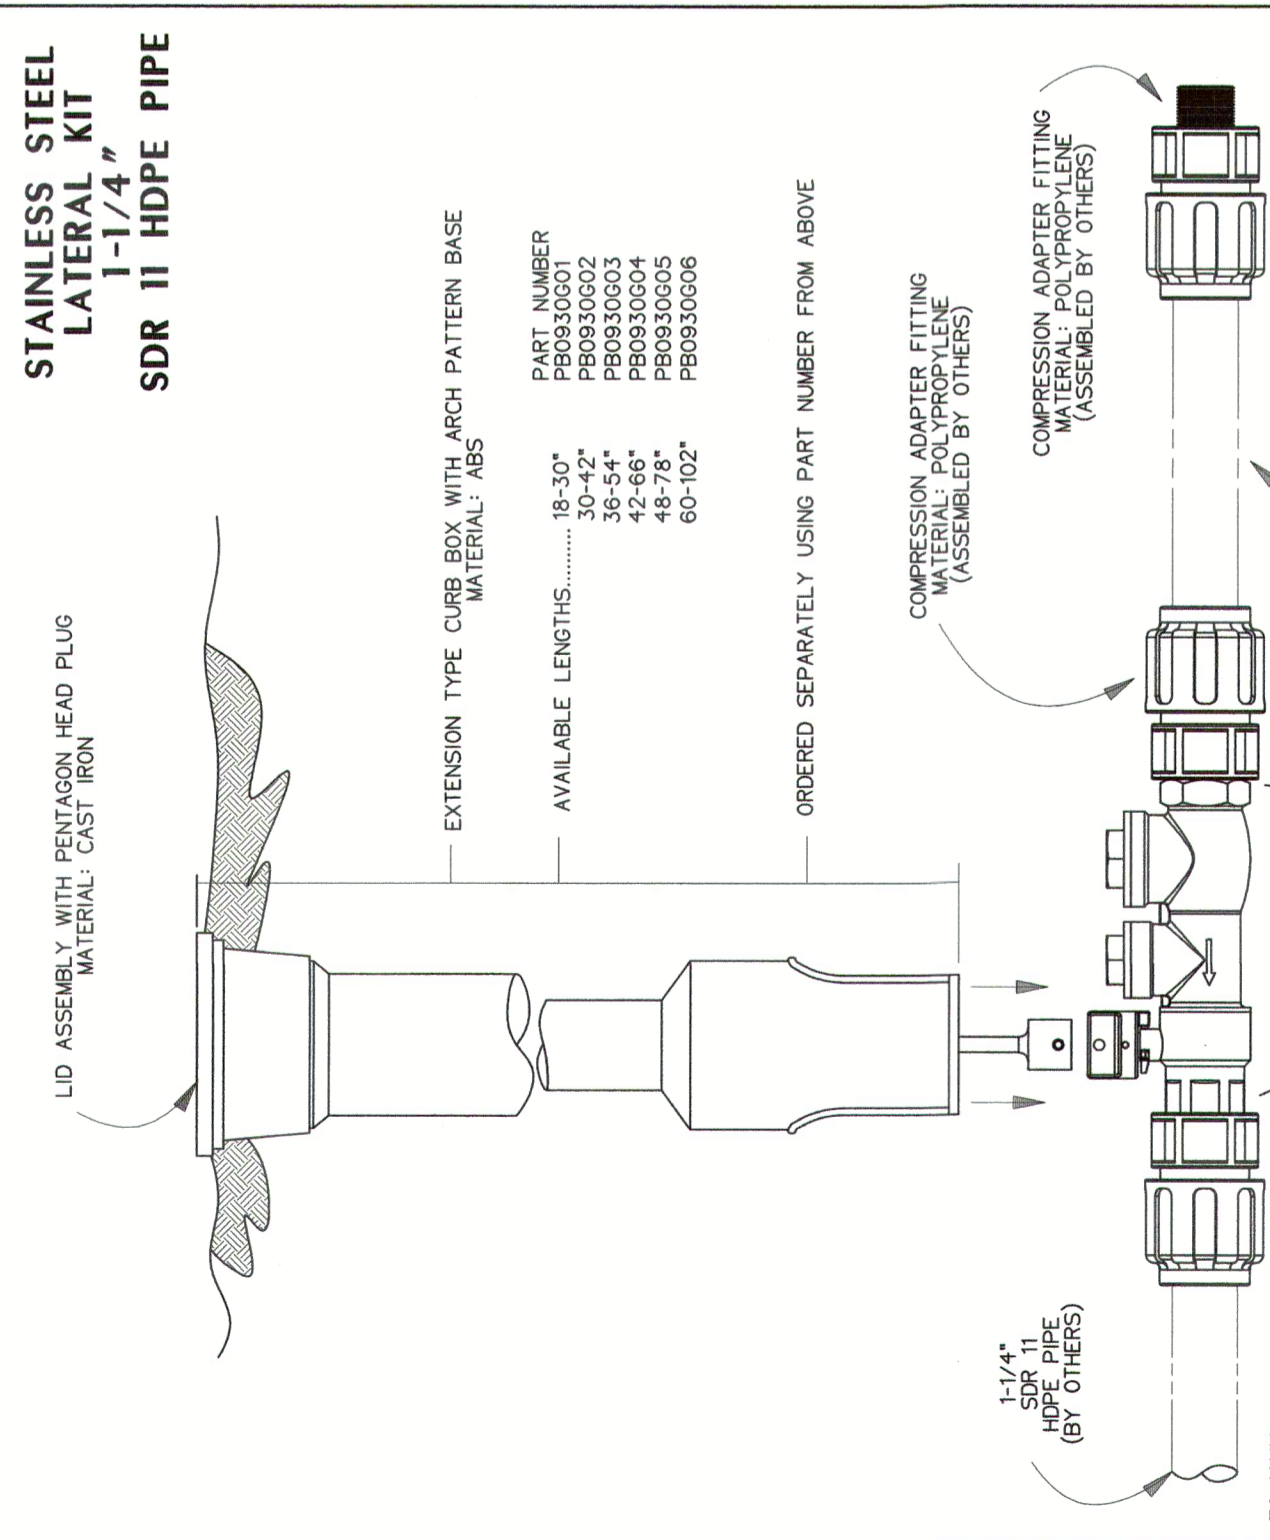

SCALE	CITY OF TORRINGTON
APPROVED	Engineering Department
DATE	STAINLESS STEEL LATERAL KIT 1-1/4\"/>
REVISION	

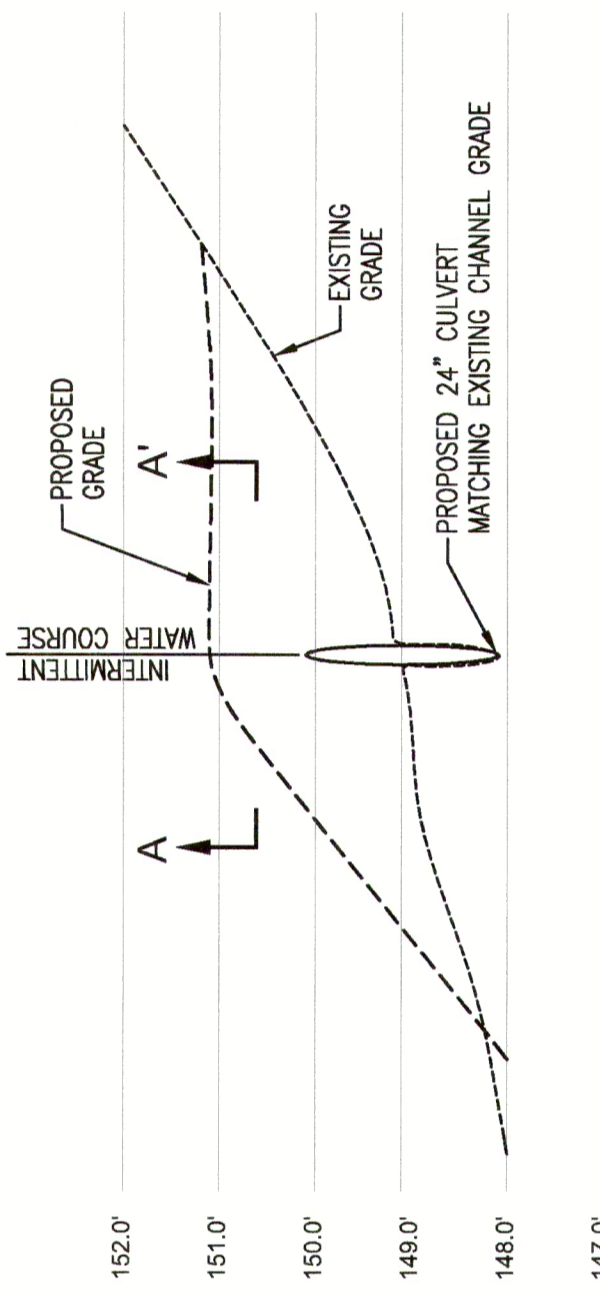

CULVERT CROSSING
CROSS SECTION A-A'
VERT. SCALE: 1/2" = 1'-0"
HORIZ. SCALE: 1" = 20'-0"