

445 Hamilton Avenue, 14th Floor White Plains, New York 10601 T 914 761 1300 F 914 761 5372 cuddyfeder.com

Kristen Motel kmotel@cuddvfeder.com

September 22, 2021

VIA ELECTRONIC MAIL AND FEDERAL EXPRESS

Chairman Greg Mele and Members of the Planning and Zoning Commission City of Torrington 140 Main Street, Room 324 Torrington, Connecticut 06790

Re: Volta Electric Vehicle Charging/Display Kiosks

Zoning Text Amendment Application

Premises: Stop & Shop, 931 Torringford Street, Torrington, CT 06790

Dear Chairman Mele and Members of the Planning and Zoning Commission:

This letter and enclosed materials are respectfully submitted on behalf of Volta Charging, LLC ("Volta"), in support of its Petition to amend the City of Torrington Zoning Regulations ("Zoning Regulations").

Volta respectfully proposes amendments to Sections 5.15.2, 5.15.5.B, and 5.15.6.B of the Zoning Regulations to permit accessory electric vehicle charging kiosks equipped with electronic displays in the Local Business ("LB") Zone, subject to specific bulk, design and visibility requirements.

In support of the proposed amendments, enclosed please find the following materials:

Exhibit A: Application to Amend the Zoning Regulations;

Exhibit B: Petition for Zoning Text Amendment;

Exhibit C: Proposed Zoning Text Amendments; and

Exhibit D: Site Plans prepared by Kimley-Horn, P.C. dated March 3, 2021, last

revised July 21, 2021.

Also enclosed is a check made payable to the City of Torrington in the amount of \$360.00 representing the zoning amendment filing fee.

We respectfully request that this matter be placed on the Planning and Zoning Commission's next available meeting Agenda for discussion and to schedule a public hearing. Should the



September 22, 2021 Page 2

Commission or City Staff have any questions regarding the enclosed, please do not hesitate to contact us. Thank you in advance for your consideration in this regard.

Sincerely,

Kristen Motel Enclosures

Cc: Volta Charging, LLC

Kimley-Horn, P.C.

Christopher B. Fisher, Esq.

Allison Fausner, Esq.

Exhibit A



Fee: \$360 (including \$60 State tax)

Rev: 3/2014

CITY OF TORRINGTON

Planning & Zoning Commission

APPLICATION FOR CHANGE OF ZONING REGULATIONS

Samuel Lee, on behalf of Volta Charging, LLC Applicant: 155 DeHaro Street, San Francisco, CA 94103 Address: Phone: 917-903-6066 Fax: E-Mail Address: samuel.lee@voltacharging.com Kristen Motel, Esq., Cuddy & Feder, LLP, Attorney for Applicant Attorney or Agent: ___ 445 Hamilton Avenue, 14th Floor, White Plains, NY 10601 Address: 914-761-5372 914-761-1300 Phone: Fax: E-Mail Address: ____kmotel@cuddyreder.com Section of Regulation Proposed to be Amended or Added: (State clearly the proposed amendment or attach brief to this application) The applicant proposes to amend Zoning Regulations Sections 5.15.2, 5.15.5.B and 5.15.6.B. See attached Zoning Regulations Petition. Signature of Applicant or Agent: FOR OFFICE USE ONLY Application Fee Paid: Date of Public Hearing: Date of Decision: Action Taken: ______

Exhibit B

PLANNING AND ZONING COMMISSION: CITY OF TORRINGTON COUNTY OF LITCHFIELD: STATE OF CONNECTICUT

----X

In the Matter of the Application of

Volta Charging, LLC

PETITION

Petition to the Amend the Zoning Regulations of the City of Torrington to Permit Electric Vehicle Charging/Display Kiosks on Parcels in the Local Business Zone that Will Apply to Real Property Located at 931 Torringford Street, Designated on the Tax Map of the City of Torrington as Section 144, Block 002, Lot 010

TO THE HONORABLE CHAIRMAN AND MEMBERS OF THE PLANNING AND ZONING COMMISSION OF THE CITY OF TORRINGTON

The Petition of Volta Charging, LLC ("Volta" or the "Petitioner") respectfully shows and alleges in support of Petitioner's request:

1. PETITIONER: Volta Charging, LLC is a corporation organized and existing under the laws of the State of Delaware and is requesting text amendments to the Zoning Regulations of the City of Torrington (the "Zoning Regulations") to permit EV Charging/Display Kiosks on parcels classified in the Local Business Zoning District, subject to specific bulk, design and visibility requirements.

Volta operates electric vehicle ("EV") charging networks throughout the United States and provides free charging in convenient locations. By generating revenue through sponsored content, Volta creates value and passes that on to EV owners who can charge while they shop. This encourages consumer adoption of electric vehicles with net reductions in carbon emissions.

Volta is partnering with Stop & Shops across the Northeast to establish on-site electric vehicle charging kiosks that enhance the shift from combustion-powered miles to electric miles. The charging kiosks include a digital display feature for various sponsored content, which enables Volta to provide the vehicle charge at no cost to the driver while it is parked on-site.

2. The Parcel & Future Proposal: The Petitioner is proposing to install two (2) EV Charging/Display Kiosks in the parking lot of the Stop & Shop located at 931 Torringford Street (the "Parcel") in the City of Torrington, Connecticut.

The Parcel is currently classified within the Local Business ("LB") Zone and is situated to the west of Torringford Street (Route 183), just south of East Main Street (Route 202). The Parcel is only improved with a Stop & Shop, there are no other retail tenants at the Parcel.

Volta proposes to convert two (2) standard parking spaces into two (2) electric vehicle spaces with charging kiosks located in existing landscaped islands. The kiosks are approximately seven and a half (7.5) feet tall and three (3) feet wide and include digital displays that are four (4) feet tall and 2½ (2.25) feet wide.

The EV Charging/Display Kiosks will be located in the first row of parking spaces, closest to the Stop & Shop building entrance to target pedestrian traffic. The kiosks are not intended for any off-site visibility and will be seen only by Stop & Shop patrons. The digital displays themselves have an auto-dimming feature and are equipped to display subtle motion with sponsored content changing at a maximum of 8-second intervals. Concept drawings and renderings of the proposed EV Charging/Display Kiosks are annexed hereto as **Exhibit D**.

3. IN FURTHERANCE OF THE CITY OF TORRINGTON'S 2019 PLAN OF CONSERVATION AND DEVELOPMENT, THE PROPOSED EV CHARGING/DISPLAY KIOSKS WILL ENHANCE SUSTAINABILITY INITIATIVES AND PROMOTE BUSINESS GROWTH: The proposed zoning text amendments will permit EV Charging/Display Kiosks in limited locations to serve and complement business areas while also promoting sustainable practices and supporting businesses development. See Exhibit C – Zoning Text Amendments.

The City of Torrington 2019 Plan of Conservation and Development ("2019 POCD") identifies the objectives of adopting sustainable practices, specifically citing the need to reduce dependence upon fossil fuels, as well as supporting transportation improvements and recruiting new industry.¹

The proposed zoning amendments will support transportation improvements that will guide future land-use consistent with the overall goals of the 2019 POCD.² Specifically, the installation of EV charging kiosks will enable citizens and travelers in the City of Torrington to reduce their dependence on fossil fuels thereby reducing emissions.³ As a member of the Connecticut Clean Energy Community Program, Torrington strives to promote clean renewable energy by reviewing its regulations to eliminate restrictions on the use of green energy.⁴ The proposed amendments are integral to encouraging the adoption of clean energy transportation options by Torrington's citizens and visitors.

In addition to the promotion of sustainability objectives, kiosks permitted under the proposed zoning amendment will promote economic growth and a supportive business environment by enhancing the City's tax base and recruiting new industry within appropriate business areas, such as the one the Torringford Stop & Shop is classified within.⁵ Moreover, the proposed zoning amendments include criterion specifically designed to ensure that EV Charging/Display Kiosks will be compatible with surrounding land uses.

Thus, amending the Zoning Regulations to permit EV Charging/Display Kiosks in business areas furthers Torrington's goals of fostering sustainability initiatives and promoting economic growth.

WHEREFORE, the Petitioner respectfully requests that this Petition be granted in its entirety thereby amending the Zoning Regulations of the City of Torrington to permit EV

¹ See 2019 POCD 12-1, 13-1, 8-3, 8-14.

² See 2019 POCD 12-1.

³ See 2019 POCD 13-1.

⁴ See 2019 POCD 13-2.

⁵ See 2019 POCD 8-2, 8-3.

Charging/Display Kiosks on parcels classified in the LB Zone subject to specific bulk, design and visibility requirements.

Dated: September 22, 2021

Respectfully submitted,

Kristen Motel

Cuddy & Feder LLP
Attorneys for Petitioners
445 Hamilton Avenue, 14th Floor
White Plains, New York 10601

Exhibit C

Exhibit A:

Proposed Zoning Text Amendment

Section 5.15.2 of the Zoning Regulations is amended to add the following definition:

"EV Charging/Display Kiosk – A combined electric vehicle charging kiosk with internally illuminated LED displays. EV charging/display kiosks must meet the following criteria:

- 1. There shall be a maximum of two EV Charging/Display Kiosks per business or business location.
- 2. EV Charging/Display Kiosks shall not exceed 21.5 square feet in size and 7.5 feet in height.
- 3. EV Charging/ Display Kiosks display screen shall not exceed 9 square feet.
- 4. EV Charging/Display Kiosks shall be equipped with an auto-dimming feature.
- 5. EV Charging/Display Kiosks shall limit content refresh rates to no more than every 8 seconds.
- 6. <u>EV Charging/Display Kiosks shall be located within 100 feet of the front façade of the business building on the site.</u>
- 7. EV Charging/Display Kiosks shall be located within a parking lot serving only one retail store with a building footprint of no less than 57,000 square feet.
- 8. <u>Any EV Charging/Display Kiosks not meeting the requirements of subsections 1 through 7 of this subsection shall be deemed a prohibited Off-Premise Sign pursuant to Section 5.15.2 of these Zoning Regulations.</u>

Section 5.15.2 of the Zoning Regulations is amended as follows (revisions indicated by underline):

Off-Premise Sign – A sign which directs attention to a business, commodity, service or activity conducted, sold, offered or held at a location other than the lot on which the sign is located. A 'billboard' is an example of an off-premise sign. An EV Charging/Display Kiosk does not constitute an Off-Premise Sign.

Section 5.15.5.B and Table 1 of the Zoning Regulations is amended to add the following:

• A row for "EV Charging/Display Kiosk" permitting EV Charging/Display Kiosks as a zoning permit use ("S") in the Local Business ("LB") Zoning District (see below).

Table 1	- Signs	by Type i	in All Z	Zoning D	istricts
---------	---------	-----------	----------	----------	----------

Sign Type	DD	LB	I	IP	CIR	Residential
Banner	S	S	S	S	S	N
Billboard	N	N	N	N	N	N
Canopy	S	S	S	S	S	N
Construction	S	S	S	S	S	S
EV Charging/Display Kiosks	<u>N</u>	<u>S</u>	<u>N</u>	<u>N</u>	<u>N</u>	<u>N</u>
Farm Directional	P	P	P	P	P	P
Flag	P	P	P	P	P	P
Free-Standing	S	S	S	S	S	S
Home Occupation	S	S	S	N	N	S

Incidental	P	P	P	P	P	N
Lamp Post Banner	P	P	N	N	N	N
Marquee	S	S	N	N	S	N
Off-Premise	N	N	N	N	N	N
Pennant	N	N	N	N	N	N
Portable Sign	S	S	N	N	S	N
Projecting Sign	S	S	N	N	N	N
Rear Entrance Sign	S	S	S	N	S	N
Residential	P	P	P	N	N	P
Residential Development	N	N	N	N	N	S
Sign						
Roof Sign	S	S	S	S	S	N
Temporary Sign	S	S	S	N	N	S
Wall Sign	S	S	S	N	N	S
Window Sign	P	P	P	P	P	N

- S = allowed with Zoning Permit
- P = allowed by right, no Zoning Permit required
- E = allowed by Special Exception approval
- N = not allowed

Section 5.15.6.B of the Zoning Regulations is amended as follows (revisions indicated by underline):

5.15.6 Sign Illumination B. No sign may contain or be illuminated by flashing or intermittent lights or lights of changing degrees of intensity except for signs that indicate time, date and temperature or gasoline sales prices or EV Charging/Display Kiosks. With the exception of EV Charging/Display Kiosks, LED or electronic changeable signs are not permitted.

Exhibit D

STOP & SHOP #2604 TORRINGTON

931 TORRINGFORD STREET TORRINGTON, CT 06790 LITCHFIELD COUNTY

E MAIN ST

ITEM	TASK	YES	NO	N/A
1	CONTACT 811 UTILITY PRIOR TO EXCAVATION WORK.			
2	NOTIFY VOLTA & KIMLEY-HORN OF ANY DISCREPANCIES W/ PLANS OR POTENTIAL CONFLICTS.			
3	VERIFY ALL FIELD CONDITIONS PRIOR TO START OF CONSTRUCTION IN ACCORDANCE WITH THESE PLANS.			
4	INSTALL WORK AREA PROTECTION MEASURES.			
5	FIELD LOCATE EXISTING UTILITIES AND CROSSINGS & VERIFY NO CONFLICTS W/PROPOSED INFRASTRUCTURE.			
6	FIELD VERIFY ALL STALL DIMENSIONS AND EQUIPMENT LOCATIONS.			
7	CONFIRM ALL ADA AND LOCAL REQUIREMENTS ARE MET.			
8	ESTABLISH TEMPORARY CONSTRUCTION ACCESS(ES).			
9	IMPLEMENT AND MAINTAIN EPSC CONTROL MEASURES PER LOCAL REQUIREMENTS.			
10	LOCATE VERTICAL AND HORIZONTAL UTILITIES PRIOR TO BORING.			
11	PROVIDE PROPOSED LIMITS OF ASPHALT OVERLAY SKETCH TO KIMLEY-HORN & VOLTA (IF NEEDED).			
12	SEED & STABILIZE ALL DISTURBED AREAS AFTER FINAL GRADING.			

E PEARL RD

Torringford

ALL WORK AND MATERIALS SHALL BE PERFORMED AND INSTALLED IN ACCORDANCE WITH THE CURRENT EDITIONS OF THE BUILDING/DWELLING, STRUCTURAL, PLUMBING, MECHANICAL, ELECTRICAL, AND FIRE/LIFE SAFETY CODES AS ADOPTED BY THE LOCAL GOVERNING AUTHORITIES. NOTHING IN THESE PLANS IS TO BE CONSTRUCTED TO PERMIT WORK NOT CONFORMING TO THE LOCAL GOVERNING AUTHORITIES CODES.

VOLTA PROPOSES:

• (2) STANDARD PARKING SPACE(S) IS/ARE TO BE CONVERTED INTO (2) STANDARD ELECTRIC VEHICLE (EV) PARKING SPACE(S). (2) ELECTRIC VEHICLE CHARGING STATION(S) IS/ARE TO BE INSTALLED IN A (STRIPED/LANDSCAPE ISLAND(S)) ADJACENT TO THE EV PARKING STALL(S). ELECTRICAL CONDUITS WILL BE EXTENDED FROM THE EXISTING BUILDING TO THE ELECTRIC VEHICLE CHARGING STATION. VOLTA WILL ALSO PAINT AND MARK ALL EV CHARGING PARKING SPACES AND INSTALL NECESSARY PARKING SIGNS.

APPLICANT:

155 DE HARO STREET SAN FRANCISCO, CA 94103 CONTACT: EVA ABENIACAR PHONE: (610)-570-9756 EMAIL: EVA.ABENIACAR@VOLTACHARGING.COM EMAIL: RYAN.GRAM@KIMLEY-HORN.COM

SITE PARTNER: STOP AND SHOP

1385 HANCOCK ST QUINCY, MA 02169 CONTACT: LINDA CAMARA PHONE: (508)-654-6851LCAMARA@STOPANDSHOP.COM

PROJECT TEAM

PROGRAM MANAGER:

KIMLEY-HORN & ASSOCIATES 1 N LEXINGTON AVE, SUITE 505 WHITE PLAINS, NY 10601 CONTACT: RYAN GRAM PHONE: (615)-564-2865

CIVIL ENGINEER: KIMLEY-HORN & ASSOCIATES

1 N LEXINGTON AVE, SUITE 505 WHITE PLAINS, NY 10601 CONTACT: MIKE JUNGHANS PHONE: (914)-368-9189 EMAIL: MIKE.JUNGHANS@KIMLEY-HORN.COM

ELECTRICAL ENGINEER:

KIMLEY-HORN & ASSOCIATES 1 N LEXINGTON AVE, SUITE 505 WHITE PLAINS, NY 10601 CONTACT: JEFFREY SALLEE PHONE: (757)-213-8635 JEFFREY.SALLEE@KIMLEY-HORN.COM

ELECTRICAL ONE LINE DIAGRAM & PANEL SCHEDULE

ELECTRICAL NOTES & DETAILS

Know what's BELOW.

CALL before you dig.

CONTRACTOR VERIFICATION CHECKLIST

SITE

VICINITY MAP

CODE BLOCK

NOT TO SCALE

LOCAL MAP

PROJECT DESCRIPTION

9.14		0.8067		
Q. M. L.			10 1	
	CITEN			
	SITE			ST
and the second		13 VIII E WY		2
1 1 1 1 1 1 1 1 1 1 1 1 1 1 1 1 1 1 1		Hall the state of		
THE STATE OF			TORRINGEO	
			ORA	
			F	
8				
NRIDGE RD				
SID				
Z				

Sheet Number	Sheet Title
C0-00	COVER SHEET
C0-01	GENERAL NOTES
C0-02	VOLTA STATION OVERV

C0-02	VOLTA STATION OVERVIEW
C1-00	OVERALL SITE PLAN
C2-00	ENLARGED SITE PLAN
C3-00	SITE DETAILS
C3-01	SITE DETAILS
C3-02	SITE DETAILS
C3-03	SITE DETAILS

SHEET INDEX

NOT TO SCALE

E1-00

E2-00



CALL AT LEAST TWO WORKING

DAYS BEFORE YOU DIG

CONTRACTOR SHALL VERIFY ALL PLANS & EXISTING LOCATIONS, CONDITIONS ON THE JOB

CALL BEFORE YOU DIG



155 DE HARO STREET SAN FRANCISCO, CA 94103



1 N LEXINGTON AVE, SUITE 505 WHITE PLAINS, NY 10601 Main: 914.368.9200 | www.kimley-horn.com © 2021 Kimley-Horn and Associates, Inc.


REV	DATE	DESCRIPTION	BY
1	03/03/2021	CD90s	TAS
2	05/05/2021	CD100s	TAS
3	07/21/2021	CD100s	TAS
			·
			·

ISSUE DATE

05/05/2021

ISSUED FOR

PERMIT

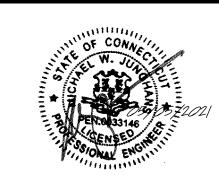

T IS A VIOLATION OF LAW FOR ANY PERSON UNLESS THEY ARE ACTING UNDER THE DIRECTION OF A LICENSED PROFESSIONAL ENGINEER, TO ALTER THIS DOCUMENT.

STOP & SHOP #2604 TORRINGTON

931 TORRINGFORD STREET TORRINGTON, CT 06790

SHEET TITLE

COVER SHEET

SHEET NUMBER

C0-00

- 1. VOLTA WILL PROVIDE AN INSTALLATION GUIDE AND OTHER SUPPORTING DOCUMENTS AT TIME OF CONSTRUCTION.
- 2. ALL EXISTING CONDITIONS SHOWN ARE APPROXIMATE. EXISTING UTILITY LOCATIONS AND CROSSINGS ARE TO BE LOCATED IN THE FIELD. CONTRACTOR IS TO CONTACT 811 UTILITY PRIOR TO BEGINNING ANY EXCAVATION WORK.
- 3. ALL PAVEMENT, LANDSCAPING, UTILITIES, AND OWNER PROPERTY THAT IS DAMAGED OR AFFECTED BY CONSTRUCTION SHALL BE RETURNED TO EXISTING CONDITIONS OR BETTER AT THE CONTRACTOR'S EXPENSE.
- 4. PROPOSED PAVEMENT STRIPING SHALL LINE UP WITH EXISTING STRIPING WHEREVER POSSIBLE, ADDITIONAL PAVEMENT STRIPE IS NOT NECESSARILY PARALLEL TO THE CONSTRUCTED CHARGING
- 5. THIS ACCESSIBILITY REVIEW WAS UNDERTAKEN TO IDENTIFY DESIGN FEATURES OF THE PROJECT THAT MAY BE CONSIDERED BY GOVERNMENTAL AGENCIES OR DEPARTMENTS. OR NON-GOVERNMENTAL GROUPS TO BE NON-COMPLIANT WITH THE AMERICANS WITH DISABILITIES ACT OF 1990, REVISED 2010 ADA REGULATIONS AND STANDARDS. THE AMERICANS WITH DISABILITIES ACT OF 1990 IS A FEDERAL CIVIL RIGHTS LAW, THERE IS NO FEDERAL REVIEW PROCESS TO ENSURE FULL COMPLIANCE WITH THE GUIDELINES, EXCEPT THROUGH THE FEDERAL COURT SYSTEM. THE DEPICTIONS, NOTES, AND RECOMMENDATIONS, EXPRESSED ON THIS PLAN ARE BASED ON PROFESSIONAL JUDGEMENT GAINED FROM PAST EXPERIENCE WITH ACCESSIBILITY LAWS, CODES, AND STANDARDS AND THE WORKING INVOLVEMENT TO DEVELOP ACCESSIBILITY STANDARDS THAT WILL MEET OR EXCEED THE APPLICABLE FEDERAL GUIDELINES ACCORDINGLY, NO CLAIMS OR WARRANTIES, EXPRESSED OR IMPLIED, ARE MADE THAT IN PREPARING THIS PLAN AND PROPOSING RECOMMENDATIONS, THAT ALL POSSIBLE BARRIERS TO ALL PEOPLE HAVE BEEN IDENTIFIED.
- 6. CONTRACTOR SHALL ACHIEVE A MINIMUM OF 1% BUT NO MORE THAN A 2% SLOPE IN ANY DIRECTION WITHIN ADJACENT ACCESSIBLE SPACE AND BLEND ASPHALT OVERLAY TO EXISTING GRADES AS REQUIRED. CONTRACTOR SHALL PROVIDE A SKETCH TO VOLTA OF PROPOSED LIMITS OF ASPHALT OVERLAY TO ACHIEVE THIS REQUIREMENT PRIOR TO BEGINNING PAVEMENT
- 7. ACCESSIBLE EV STALLS WERE DESIGNED BASED ON EXISTING CONDITIONS AND WITHOUT THE BENEFIT OF SURVEY DATA. ALL ADA AND LOCAL REQUIREMENTS INCLUDING BUT NOT LIMITED TO SLOPE AND SPACING SHALL BE CONFIRMED BY THE CONTRACTOR AND MET AT THE TIME OF CONSTRUCTION
- 8. CONTRACTOR TO NOTIFY THE ENGINEER OF ANY DISCREPANCIES IN ACCESSIBILITY PRIOR TO CONSTRUCTION
- 9. UNDER NO CIRCUMSTANCE IS THE CONTRACTOR TO DISRUPT ANY OPERATIONS AT THE SITE HOST LOCATION, INCLUDING BUT NOT LIMITED TO CUSTOMER DISRUPTION, UTILITIES, AND INFRASTRUCTURE.
- 10. CONTRACTOR SHALL BE RESPONSIBLE TO PROTECT WORK AREAS WITH CONES AND/OR BARRICADES AT ALL TIMES.

EROSION CONTROL & GRADING NOTES:

UPON COMPLETION.

- ADDITIONAL EROSION CONTROL DEVICES TO BE USED AS REQUIRED BY LOCAL INSPECTOR 2. DISTURBED AREAS LEFT IDLE FOR FIVE DAYS, AND NOT TO FINAL GRADE, WILL BE ESTABLISHED TO TEMPORARY VEGETATION. MULCH, TEMPORARY VEGETATION OR PERMANENT VEGETATION SHALL BE COMPLETED ON ALL EXPOSED AREAS WITHIN 14 DAYS AFTER DISTURBANCE. ALL AREAS TO FINAL GRADE WILL BE ESTABLISHED TO PERMANENT VEGETATION
- 3. WHEN HAND PLANTING, MULCH (HAY OR STRAW) SHOULD BE UNIFORMLY SPREAD OVER SEEDED AREA WITHIN 24 HOURS OF SEEDING. IF UNABLE TO ACCOMPLISH, MULCH SHALL BE USED AS A TEMPORARY COVER. CONCENTRATED FLOW AREAS AND ALL SLOPES STEEPER THAN 2.5:1 AND WITH A HEIGHT OF TEN FEET OR GREATER (DOES NOT APPLY TO RETAINING WALLS), AND CUTS AND FILLS WITHIN BUFFERS, SHALL BE STABILIZED WITH THE APPROPRIATE EROSION CONTROL MATTING OR BLANKETS.
- 4. THE ESCAPE OF SEDIMENT FROM THE SITE SHALL BE PREVENTED BY THE INSTALLATION OF EROSION AND SEDIMENT CONTROL MEASURES AND PRACTICES PRIOR TO, OR CONCURRENT WITH, LAND-DISTURBING ACTIVITIES.
- 5. EROSION CONTROL MEASURES WILL BE MAINTAINED AT ALL TIMES. IF FULL IMPLEMENTATION OF THE PLAN DOES NOT PROVIDE FOR EFFECTIVE EROSION CONTROL, ADDITIONAL EROSION CONTROL AND SEDIMENT CONTROL MEASURES SHALL BE IMPLEMENTED TO CONTROL OR TREAT THE SEDIMENT SOURCE.
- 6. SEED ALL DISTURBED AREAS UNLESS OTHERWISE NOTED AS PART OF THIS CONTRACT. 7. THE CONTRACTOR SHALL DETERMINE THE EXACT LOCATION OF ALL EXISTING UTILITIES BEFORE COMMENCING WORK AND AGREES TO BE RESPONSIBLE FOR ANY AND ALL DAMAGES WHICH MIGHT RESULT FROM THE CONTRACTOR'S FAILURE TO EXACTLY LOCATE AND PRESERVE ANY UNDERGROUND UTILITIES TO REMAIN. THE CONTRACTOR IS TO NOTIFY ENGINEER IMMEDIATELY OF ANY DISCREPANCIES AND/OR CONFLICTS WITH EXISTING OR PROPOSED UTILITIES PRIOR TO
- 8. STOCKPILED TOPSOIL OR FILL MATERIAL IS TO BE TREATED SO THE SEDIMENT RUN-OFF WILL NOT CONTAMINATE SURROUNDING AREAS OR ENTER NEARBY STREAMS. STOCK PILE LOCATIONS SHALL BE COORDINATED WITH THE ENGINEER PRIOR TO GRADING ACTIVITIES. EROSION & SEDIMENT CONTROL PRACTICE SHALL BE INSTALLED PRIOR TO STOCKPILE OPERATIONS. 9. CONSTRUCT SILT BARRIERS BEFORE BEGINNING GRADING OPERATIONS.
- 10. MULCH AND SEED ALL DISTURBED AREAS AS SOON AS POSSIBLE AFTER FINAL GRADING IS COMPLETED (WITHIN 15 DAYS OF ACHIEVED FINAL GRADES) UNLESS OTHERWISE INDICATED. CONTRACTOR SHALL TAKE WHATEVER MEANS NECESSARY TO ESTABLISH PERMANENT SOIL STABILIZATION. STEEP SLOPES (GREATER THAN 3:1) SHALL BE STABILIZED WITHIN 7 DAYS OF
- 11. PROVIDE TEMPORARY CONSTRUCTION ACCESS(ES) AT THE POINT(S) WHERE CONSTRUCTION VEHICLES EXIT THE CONSTRUCTION AREA. MAINTAIN PUBLIC ROADWAYS FREE OF TRACKED MUD AND DIRT.
- 12. DO NOT DISTURB VEGETATION OR REMOVE TREES EXCEPT WHEN NECESSARY FOR GRADING

ADA COMPLIANCE:

- 1. CURB RAMPS ALONG PUBLIC STREETS AND IN THE PUBLIC RIGHT-OF-WAY SHALL BE CONSTRUCTED BASED ON THE CITY STANDARD CONSTRUCTION DETAILS AND SPECIFICATIONS.
- 2. PRIVATE CURB RAMPS ON THE SITE (I.E. OUTSIDE PUBLIC STREET RIGHT-OF-WAY) SHALL CONFORM TO ADA STANDARDS AND SHALL HAVE A DETECTABLE WARNING SURFACE THAT IS FULL WIDTH AND FULL DEPTH OF THE CURB RAMP, NOT INCLUDING FLARES.
- 3. ALL ACCESSIBLE ROUTES, GENERAL SITE AND BUILDING ELEMENTS, RAMPS, CURB RAMPS, STRIPING, AND PAVEMENT MARKINGS SHALL CONFORM TO ADA STANDARDS FOR ACCESSIBLE DESIGN, LATEST EDITION.
- 4. BEFORE PLACING PAVEMENT, CONTRACTOR SHALL VERIFY THAT SUITABLE ACCESSIBLE PEDESTRIAN ROUTES (PER ADA AND FHA) EXIST TO AND FROM EVERY DOOR AND ALONG SIDEWALKS, ACCESSIBLE PARKING SPACES, ACCESS AISLES, AND ACCESSIBLE ROUTES. IN NO CASE SHALL AN ACCESSIBLE RAMP SLOPE EXCEED 1 VERTICAL TO 12 HORIZONTAL. IN NO CASE SHALL SIDEWALK CROSS SLOPE EXCEED 2.0 PERCENT. IN NO CASE SHALL LONGITUDINAL SIDEWALK SLOPE EXCEED 5.0 PERCENT. ACCESSIBLE PARKING SPACES AND ACCESS AISLES SHALL NOT EXCEED 2.0 PERCENT SLOPE IN ANY DIRECTION.
- 5. CONTRACTOR SHALL TAKE FIELD SLOPE MEASUREMENTS ON FINISHED SUBGRADE AND FORM BOARDS PRIOR TO PLACING PAVEMENT TO VERIFY THAT ADA SLOPE REQUIREMENTS ARE PROVIDED. CONTRACTOR SHALL CONTACT ENGINEER PRIOR TO PAVING IF ANY EXCESSIVE SLOPES ARE ENCOUNTERED. NO CONTRACTOR CHANGE ORDERS WILL BE ACCEPTED FOR ADA SLOPE COMPLIANCE ISSUES.


SITE NOTES:


- 1. HORIZONTAL DIRECTIONAL DRILLING (HDD) OR OTHER TRENCHLESS METHODS AS APPROVED BY SITE HOST ARE THE PREFERRED METHOD TO INSTALL CONDUIT BENEATH EXISTING PARKING LOTS AND PAVED AREAS.
- 1.1. CONDUIT SHALL BE INSTALLED AT A MINIMUM DEPTH OF TWO AND ONE—HALF FEET (2.5') OR BELOW THE FREEZE LINE, WHICHEVER IS DEEPER. CONDUIT TYPE AND DESIGN TO BE SPECIFIED BY EV CHARGING STATION VENDOR AND MEET ALL LOCAL REQUIREMENTS. CONDUIT DIAMETER SHALL BE NO LARGER THAN TWO (2) INCHES.
- THE RECEIVING PIT SHALL BE LOCATED AS CLOSE AS REASONABLY POSSIBLE TO THE PROPOSED WALL PENETRATION TO LIMIT THE LENGTH OF BUILDING-MOUNTED CONDUIT. LOCATE RECEIVING PIT WITHIN ASPHALT PAVED AREA OR CONCRETE SIDEWALK AREA; RECEIVING PIT SHALL NOT BE LOCATED WITHIN THE UNLOADING PAD SIX TO TEN INCH (6-10") REINFORCED CONCRETE SLAB AT THE REAR OF THE STORE]. RECEIVING PIT LOCATION AND WORK AREA SHALL NOT AFFECT SITE HOST CUSTOMER OR DELIVERY TRAFFIC. SEE SUPPLEMENTAL DOCUMENTS, RECEIVING AREA DIAGRAM.
- 1.3. THE RECEIVING PIT SIZE SHALL BE LIMITED TO THREE FEET (3') BY THREE FEET (3') AND SHALL NOT UNDERMINE THE BUILDING FOUNDATION, ENCLOSURES OR CONCRETE UNLOADING
- 1.4. BACKFILL EXCAVATIONS AND REPAIR PAVEMENT PER SPECIFICATIONS BELOW.
- 1.5. WHERE CONCRETE PAVEMENT, SIDEWALK, ASPHALT PAVEMENT, CURBING, OR CURBING GUTTER IS REMOVED, THE WIDTH OF THE REMOVAL SHALL EXCEED THE ACTUAL WIDTH AT THE TOP OF THE TRENCH BY TWELVE INCHES (12") ON EACH SIDE OF THE TRENCH, OR A TOTAL OF TWO FEET (2') WIDER THAN THE TRENCH.
- TRENCHING THROUGH THE CONCRETE RECEIVING PAD AT THE REAR OF THE STORE OR THE DRIVE-THRU SLAB IS NOT ALLOWED. ONLY TRENCHING THROUGH MINOR CONCRETE INSTALLATIONS SUCH AS SIDEWALKS WILL BE PERMITTED.
- 1.7. EXCAVATE TRENCHES TO A DEPTH FOUR INCHES (4") DEEPER THAN BOTTOM OF FINISHED PIPE ELEVATION.
- THE BOTTOM WIDTH OF THE TRENCH SHALL BE AS REQUIRED TO PERMIT CONDUIT TO BE PROPERLY LAIN AND BACKFILL TO BE PLACED AND PROPERLY COMPACTED. 1.9. REMOVED PAVEMENT, CONCRETE AND EXCAVATED MATERIALS UNSUITABLE FOR USE AS BACKFILL SHALL BE DISPOSED OFFSITE.
- 1.10. BEDDING AND BACKFILL MAY BE MATERIAL EXCAVATED FROM THE TRENCH PROVIDED THAT IT IS FREE FROM DEBRIS AND ROCKS LARGER THAN ONE AND ONE-HALF INCHES (1-1/2").
- 1.11. OVER THE PIPE, IN LAYERS NOT EXCEEDING FOUR INCHES (4"), PLACE AND COMPACT SUITABLE FILL MATERIAL TO NINETY-FIVE PERCENT (95%) DRY DENSITY AS DETERMINED BY
- 1.12. COMPACTING EQUIPMENT SHALL BE OF SUCH DESIGN, WEIGHT, AND QUALITY AS IS REQUIRED TO OBTAIN THE DENSITIES SPECIFIED HEREIN OR INDICATED ON THE DESIGN DRAWINGS. AREAS INACCESSIBLE TO SELF-PROPELLED COMPACTING EQUIPMENT SHALL BE COMPACTED OR CONSOLIDATED BY HAND-OPERATED MECHANICAL TAMPERS OR VIBRATORS.
- 1.13. RESTORE GRASS, LANDSCAPING, IRRIGATION AND ALL FEATURES TO THEIR PRECONSTRUCTION 2. ANY UTILITIES, PAVEMENT, IRRIGATION, LANDSCAPING OR OTHER SITE FEATURES DAMAGED
- DURING CONSTRUCTION SHALL BE REPAIRED BY EV CHARGING STATION VENDOR TO SITE HOST SPECIFICATION. 2.1. WHERE LANDSCAPING IS IMPACTED, IT IS THE RESPONSIBILITY OF EV CHARGING STATION
- VENDOR TO REPOSITION OR PROVIDE NEW LANDSCAPING WITHIN THE SITE HOST PROPERTY TO ENSURE COMPLIANCE WITH ANY CODE REQUIREMENTS. 2.2. WHERE PARKING LOT, SIDEWALK OR OTHER PAVED AREAS ARE IMPACTED OR DAMAGED, IT IS THE RESPONSIBILITY OF THE EV CHARGING STATION VENDOR TO REPAIR THE AREA TO

LIKE NEW CONDITION, REPAIR SHOULD EXTEND BEYOND DAMAGED AREA TO NEAREST CLEAN

- BREAK THAT ALIGNS WITH ARCHITECTURAL BREAKS, MATERIAL JOINTS, PAVEMENT MARKINGS, 3. WHERE APPLICABLE, UTILITY SERVICE PROVIDER TO USE SITE HOST APPROVED ROE (RIGHT OF ENTRY) AGREEMENT. SITE HOST PROGRAM MANAGER WILL PROVIDE TEMPLATE WHEN NECESSARY.
- 4. ASPHALT PAVEMENT REMOVAL AND REPLACEMENT 4.1. SAW CUT THE PAVEMENT TO NEAT, STRAIGHT LINES TO THE FULL DEPTH OF THE PAVEMENT. PAVEMENT REMOVAL SHALL EXTEND A MINIMUM OF TWELVE INCHES (12") BEYOND THE EDGES OF THE REMOVAL AREA. ANY OTHER PAVEMENT AREAS DAMAGED
- DURING REMOVAL SHALL ALSO BE REPAIRED OR REPLACED AS NECESSARY 4.2. REMOVE THE PAVEMENT WITHOUT DAMAGING THE PAVEMENT THAT IS TO REMAIN IN-PLACE. 4.3. IF BASE REPLACEMENT IS REQUIRED, COMPACT THE IN-SITU SOILS TO NINETY-FIVE
- PERCENT (95%) ASTM D698 AND PLUS OR MINUS TWO PERCENT (2%) OF OPTIMUM MOISTURE CONTENT. REMOVE AND REPLACE ANY UNSUITABLE IN-SITU SOILS. 4.4. PLACE AND COMPACT BASE MATERIAL TO NINETY-FIVE PERCENT (95%) OF ASTM D698. 4.5. APPLY PRIME COAT TO AGGREGATE BASE IN COMPLIANCE WITH THE DOT SPECS. PRIME
- COAT SHALL NOT BE APPLIED MORE THAN TWENTY-FOUR (24) HOURS BEFORE ASPHALT PAVEMENT IS PLACED. APPLICATION RATE TO BE PER THE DOT SPEC. 4.6. CLEAN AND APPLY TACK COAT TO THE ENDS OF CURBS, EDGES OF CONCRETE SURFACES,
- EDGES OF MANHOLES AND INLETS AND EDGES OF SAW CUT PAVEMENT THAT WILL REMAIN 4.7. PLACE AND COMPACT HOT-MIX ASPHALT. HOT-MIX ASPHALT THICKNESS SHALL BE THE
- GREATER OF THE IN-PLACE ASPHALT OR THREE AND ONE-HALF INCHES (3.5"). ASPHALT MIX DESIGN SHALL BE BY THE CONTRACTOR. 4.8. PLANT MIXED ASPHALT BASE/BINDER COURSE: PROVIDE ONE COURSE LAID TO A MINIMUM
- COMPACTED THICKNESS OF TWO INCHES (2").
- 4.9. PLANT MIXED ASPHALT SURFACE COURSE: PROVIDE ONE COURSE LAID TO A MINIMUM
- COMPACTED THICKNESS OF ONE AND ONE-HALF INCHES $(1-1/2)^2$. 4.10. FOR SMALLER JOBS, IT MAY NOT BE FEASIBLE TO INSTALL BINDER AND SURFACE COURSES, IN WHICH CASE SURFACE COURSE, PLACED AND COMPACTED IN TWO LIFTS, WILL BE
- 4.11. IF PLACING HOT MIX ASPHALT WITH A SHOVEL, BEGIN PLACING HMA AGAINST THE EDGES OF THE PATCH AND WORKING INWARD. HMA SHOULD NOT BE PLACED IN THE CENTER OF THE PATCH AND RAKED TOWARDS THE EDGES.
- 4.12. THE FIRST PASS OF THE ROLLER OR COMPACTION EQUIPMENT SHOULD BE ALONG THE EDGES OF THE PATCH TO PROPERLY FORM THE JOINT. THE ROLLER WHEEL OR COMPACTION EQUIPMENT SHOULD OVERHANG THE EXISTING PAVEMENT ONTO THE PATCH BY SIX INCHES (6"). AFTER THE PERIMETER OF THE PATCH HAS BEEN COMPACTED BEGIN TO WORK TOWARDS THE CENTER OF THE PATCH WITH SUCCESSIVE PASSES OFFSET BY SIX INCHES (6").
- 4.13. THE CONTRACTOR SHALL UTILIZE THE APPROPRIATE HEAVY COMPACTION EQUIPMENT TO ACHIEVE THE REQUIRED COMPACTION OF THE ASPHALT.
- 4.14. SEAL THE AREA AROUND THE EDGES WITH AN ELASTOMERIC LIQUID ASPHALT SEALER TO PROTECT AGAINST WATER INFILTRATION, INCLUDING ANY INADVERTENT OVERCUTS DURING THE SAW CUTTING PROCEDURE.

PROJECT LEGEND: (SCALE VARIES PER SHEET)

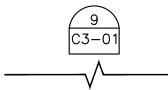

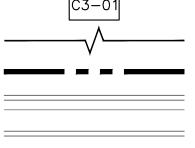

SHEET NO.

BREAK LINE

PROPERTY LINE

EXISTING CURB AND GUTTER

EXISTING CURB EXISTING PARKING STRIPE

> EXISTING CONCRETE PAD EXISTING TREE

EXISTING SHRUB

EXISTING FIRE HYDRANT

EXISTING CURB INLET

EXISTING INLET

EXISTING CATCH BASIN

EXISTING MANHOLE

EXISTING POWER POLE EXISTING LIGHT POLE

EXISTING SIGN

EXISTING ELECTRICAL ROOM

PROPOSED ELECTRICAL CONDUIT

PROPOSED ELECTRICAL JUNCTION BOX

PROPOSED COMMUNICATIONS CONDUIT PROPOSED COMMUNICATIONS JUNCTION BOX

PROPOSED CURB AND GUTTER

PROPOSED CURB

PROPOSED PARKING STRIPE

PROPOSED CONCRETE PAD

PROPOSED CONCRETE WHEEL STOP

---- TP ----- PROPOSED TREE PROTECTION

PROPOSED VOLTA CHARGING STATION

EVCS FOUNDATION W/ 4" PIPE BOLLARDS

PCS FOUNDATION

PCS FOUNDATION W/ 4" BOLLARDS

REMOTE HOLSTER RAISED FOUNDATION WITH 6" CURB

REMOTE HOLSTER FLUSH FOUNDATION PROPOSED SIGN POST

PROPOSED SIGN POST W/ BOLLARD

PROPOSED POST INSTALLED SIGN POST

PROPOSED 4" ISOLATED PIPE BOLLARD

PROPOSED POST INSTALLED SIGN POST W/ BOLLARD



155 DE HARO STREET

SAN FRANCISCO, CA 94103



1 N LEXINGTON AVE, SUITE 505 WHITE PLAINS, NY 10601 Main: 914.368.9200 | www.kimley-horn.com © 2021 Kimley-Horn and Associates, Inc.

REV	DATE	DESCRIPTION	BY
\triangle	03/03/2021	CD90s	TAS
2	05/05/2021	CD100s	TAS
3	07/21/2021	CD100s	TAS

ISSUE DATE

05/05/2021

ISSUED FOR

PERMIT



IT IS A VIOLATION OF LAW FOR ANY PERSON, UNLESS THEY ARE ACTING UNDER THE DIRECTION OF A LICENSED PROFESSIONAL ENGINEER, TO ALTER THIS DOCUMENT.

STOP & SHOP #2604 TORRINGTON

931 TORRINGFORD STREET TORRINGTON, CT 06790

SHEET TITLE

GENERAL NOTES

SHEET NUMBER

C0-01

Volta Gen4 L2 Station



Volta provides turn-key Electric Vehicle (EV) charging services for premium retail and entertainment destinations. We install and maintain the charging amenity at no cost to site partners as well as EV drivers, driving increased property value and attracting more customers who stay longer.

VOLTA STATION BENEFITS

- · Installation, equipment and maintenance is paid by Volta
- Charges all electric vehicles
- Free electricity supported through third party content on displays
- · Volta stations are occupied 80% of the retail day
- Volta has provided 88M free sponsored electric miles, delivered
 25 gigawatt hours and eliminated over 39M pounds of CO2 emissions

CHARGING UNIT INFORMATION (Single Charging Units)

- Size: H 85.0" x W 36.5" x D 15.5"
- Display Size: H 48" x W 27
- Power Type: 208/240VAC, 48A, 10kW max; UL 2202
- Plug: SAE J1772 compliant connector

POWER REQUIREMENTS

- · Charging unit: 60A/2P, 208/240 breaker
- Display/connectivity: 20A/1P, 120V breaker

INSTALLATION REQUIREMENTS

- · Wire Diameter: #6 AWG minimum. Larger for longer conduit runs
- Conduit Diameter: 1.5" minimum per station. Larger conduit required for runs over 250'



	55" Media Display
il entre	Charges up to 30miles per hou
	Universal J1772 connections
	Cable Management
	Fully Networked

Proprietary & Confidential - Do Not Distribute





1 N LEXINGTON AVE, SUITE 505 WHITE PLAINS, NY 10601 in: 914.368.9200 | www.kimley-horn.com

REV	DATE	DESCRIPTION	BY
<u>1</u>	03/03/2021	CD90s	TAS
2	05/05/2021	CD100s	TAS
3	07/21/2021	CD100s	TAS

ISSUE DATE

05/05/2021

ISSUED FOR

PERMIT

FOR INFORMATIONAL PURPOSES ONLY

IT IS A VIOLATION OF LAW FOR ANY PERSON, UNLESS THEY ARE ACTING UNDER THE DIRECTION OF A LICENSED PROFESSIONAL ENGINEER, TO ALTER THIS DOCUMENT.

STOP & SHOP #2604 TORRINGTON

931 TORRINGFORD STREET TORRINGTON, CT 06790

SHEET TITLE

VOLTA STATION OVERVIEW

SHEET NUMBER

CO-02

volta



DISCLAIMER

THESE DRAWINGS WERE PRODUCED WITHOUT THE BENEFIT OF A CURRENT LAND SURVEY. ALL PROPERTY LINES, EASEMENTS, SETBACKS, EXISTING INFRASTRUCTURE AND TITLE DOCUMENTS SHALL BE VERIFIED PRIOR TO START OF CONSTRUCTION. KIMLEY—HORN AND VOLTA DO NOT GUARANTEE THE ACCURACY OF SAID PROPERTY LINES, EASEMENTS, SETBACKS, EXISTING INFRASTRUCTURE AND TITLE DOCUMENTS.

CONTRACTOR IS RESPONSIBLE FOR VERIFYING ALL FIELD CONDITIONS AND IS TO ALERT THE ENGINEER AND VOLTA OF ANY DISCREPANCIES PRIOR TO STARTING CONSTRUCTION. CONTRACTOR TO COORDINATE WITH VOLTA PM FOR ALL FINAL PLACEMENTS OF INFRASTRUCTURE.

CONSTRUCTION NOTES:

- CONTRACTOR RESPONSIBILITIES CONSISTS OF, BUT NOT LIMITED TO, CHARGING STATION MOUNTING, FOUNDATION CONSTRUCTION, CONDUIT INSTALLATION, AND WIRING.
- CONTRACTOR TO PAINT PROPOSED EV PARKING SPACES PER JURISDICTIONAL REQUIREMENTS.
- . CONTRACTOR TO INSTALL TREE PROTECTION FENCING PRIOR TO ANY CONSTRUCTION ACTIVITY. SEE SHEET C3-00 FOR DETAILS.
- . EXACT STATION PLACEMENT AND ROTATION ANGLE MAY VARY SLIGHTLY UPON INSTALLATION DEPENDING ON SITE CONDITIONS.
- 5. CONTRACTOR TO FIELD VERIFY ALL STALL DIMENSIONS AND ALL EQUIPMENT LOCATIONS TO ENSURE SUFFICIENT SPACE IS CONTRACTOR SHALL TAKE NECESSARY PRECAUTIONS WHEN
- DRILLING INTO EXISTING CIP SLAB AND CIP DROP PANELS TO AVOID DAMAGE TO ANY REINFORCING AND EXISTING STRUCTURAL COMPONENTS.
- USE APPROVED ASTM METHOD (X-RAY, PACOMETER, GPR, ETC.) TO LOCATE MILD STEEL AND PRE-STRESSING TENDONS PRIOR TO DRILLING. DO NOT CUT OR DRILL THROUGH ANY EXISTING REINFORCING. ADJUST LOCATION AS NECESSARY TO AVOID EXISTING REINFORCING.ENSURE 1" GAP MIN. BETWEEN REBAR AND ANCHORAGE.
- 8. VOLTA WILL MAKE EVERY EFFORT TO FOLLOW, WITH THEIR PROPOSED CONDUIT, AN EXISTING CONDUIT ROUTE FROM ELECTRICAL ROOM TO PROPOSED STATION PLACEMENTS. WHEN AN EXISTING ROUTE IS NOT AVAILABLE, VOLTA WILL MAKE EVERY EFFORT TO CONCEAL/HIDE, PAINT AND MINIMIZE VISUAL IMPACT OF CONDUITS ANYWHERE THEY MAY BE VISIBLE TO THE
- 9. CONTRACTOR IS RESPONSIBLE TO LOCATE ALL VERTICAL AND HORIZONTAL UTILITIES PRIOR TO DIRECTIONAL BORING. ANY ALTERATIONS TO THE PROPOSED CONDUIT ROUTE ARE TO BE COORDINATED WITH THE PROFESSIONAL ENGINEER(S) PRIOR TO CONSTRUCTION.
- 10. ANY ITEMS TO REMAIN THAT ARE DAMAGED BY THE CONTRACTOR SHALL BE REPLACED TO THE EXISTING CONDITION OR BETTER AT THE CONTRACTOR'S EXPENSE.
- 11. CONTRACTOR TO LOCATE JUNCTION BOX OR APPROVED ALTERNATIVE FOR SITE SPECIFIC RUN LENGTHS AND BENDS.

PARKING NOTE:

FOR THE PURPOSE OF THIS PLAN IT IS ASSUMED THERE IS ADEQUATE PARKING IN EXISTING CONDITIONS TO CONVERT 2 PARKING SPACES TO 2 EV PARKING SPACES.

REFERENCE NOTE:

1. SEE PROJECT LEGEND ON SHEET CO-01 FOR SYMBOLS AND LINE TYPE DESCRIPTIONS.



155 DE HARO STREET SAN FRANCISCO, CA 94103



1 N LEXINGTON AVE, SUITE 505 WHITE PLAINS, NY 10601 Main: 914.368.9200 | www.kimley-horn.com © 2021 Kimley-Horn and Associates, Inc.

REV	DATE	DESCRIPTION	BY
1	03/03/2021	CD90s	TAS
2	05/05/2021	CD100s	TAS
3	07/21/2021	CD100s	TAS

ISSUE DATE

05/05/2021

ISSUED FOR

PERMIT



IT IS A VIOLATION OF LAW FOR ANY PERSON, UNLESS THEY ARE ACTING UNDER THE DIRECTION OF A LICENSED PROFESSIONAL ENGINEER, TO ALTER THIS DOCUMENT.

STOP & SHOP #2604 TORRINGTON

931 TORRINGFORD STREET TORRINGTON, CT 06790

SHEET TITLE

OVERALL SITE PLAN

SHEET NUMBER

C1-00

IMAGE REFERENCE:

AERIAL IMAGE(S) PROVIDED BY NEARMAP IMAGERY ©2021 Nearmap, HERE



GRAPHIC SCALE IN FEET

OVERALL SITE PLAN





155 DE HARO STREET SAN FRANCISCO, CA 94103



1 N LEXINGTON AVE, SUITE 505 WHITE PLAINS, NY 10601 Main: 914.368.9200 | www.kimley-horn.com © 2021 Kimley-Horn and Associates, Inc.


REV	DATE	DESCRIPTION	ВҮ
<u> </u>	03/03/2021	CD90s	TAS
2	05/05/2021	CD100s	TAS
3	07/21/2021	CD100s	TAS

ISSUE DATE

05/05/2021

ISSUED FOR

PERMIT

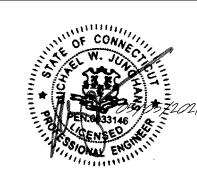

IT IS A VIOLATION OF LAW FOR ANY PERSON, UNLESS THEY ARE ACTING UNDER THE DIRECTION OF A LICENSED PROFESSIONAL ENGINEER, TO ALTER THIS DOCUMENT.

STOP & SHOP #2604 TORRINGTON


931 TORRINGFORD STREET TORRINGTON, CT 06790


SHEET TITLE

ENLARGED SITE PLAN

SHEET NUMBER

C2-00

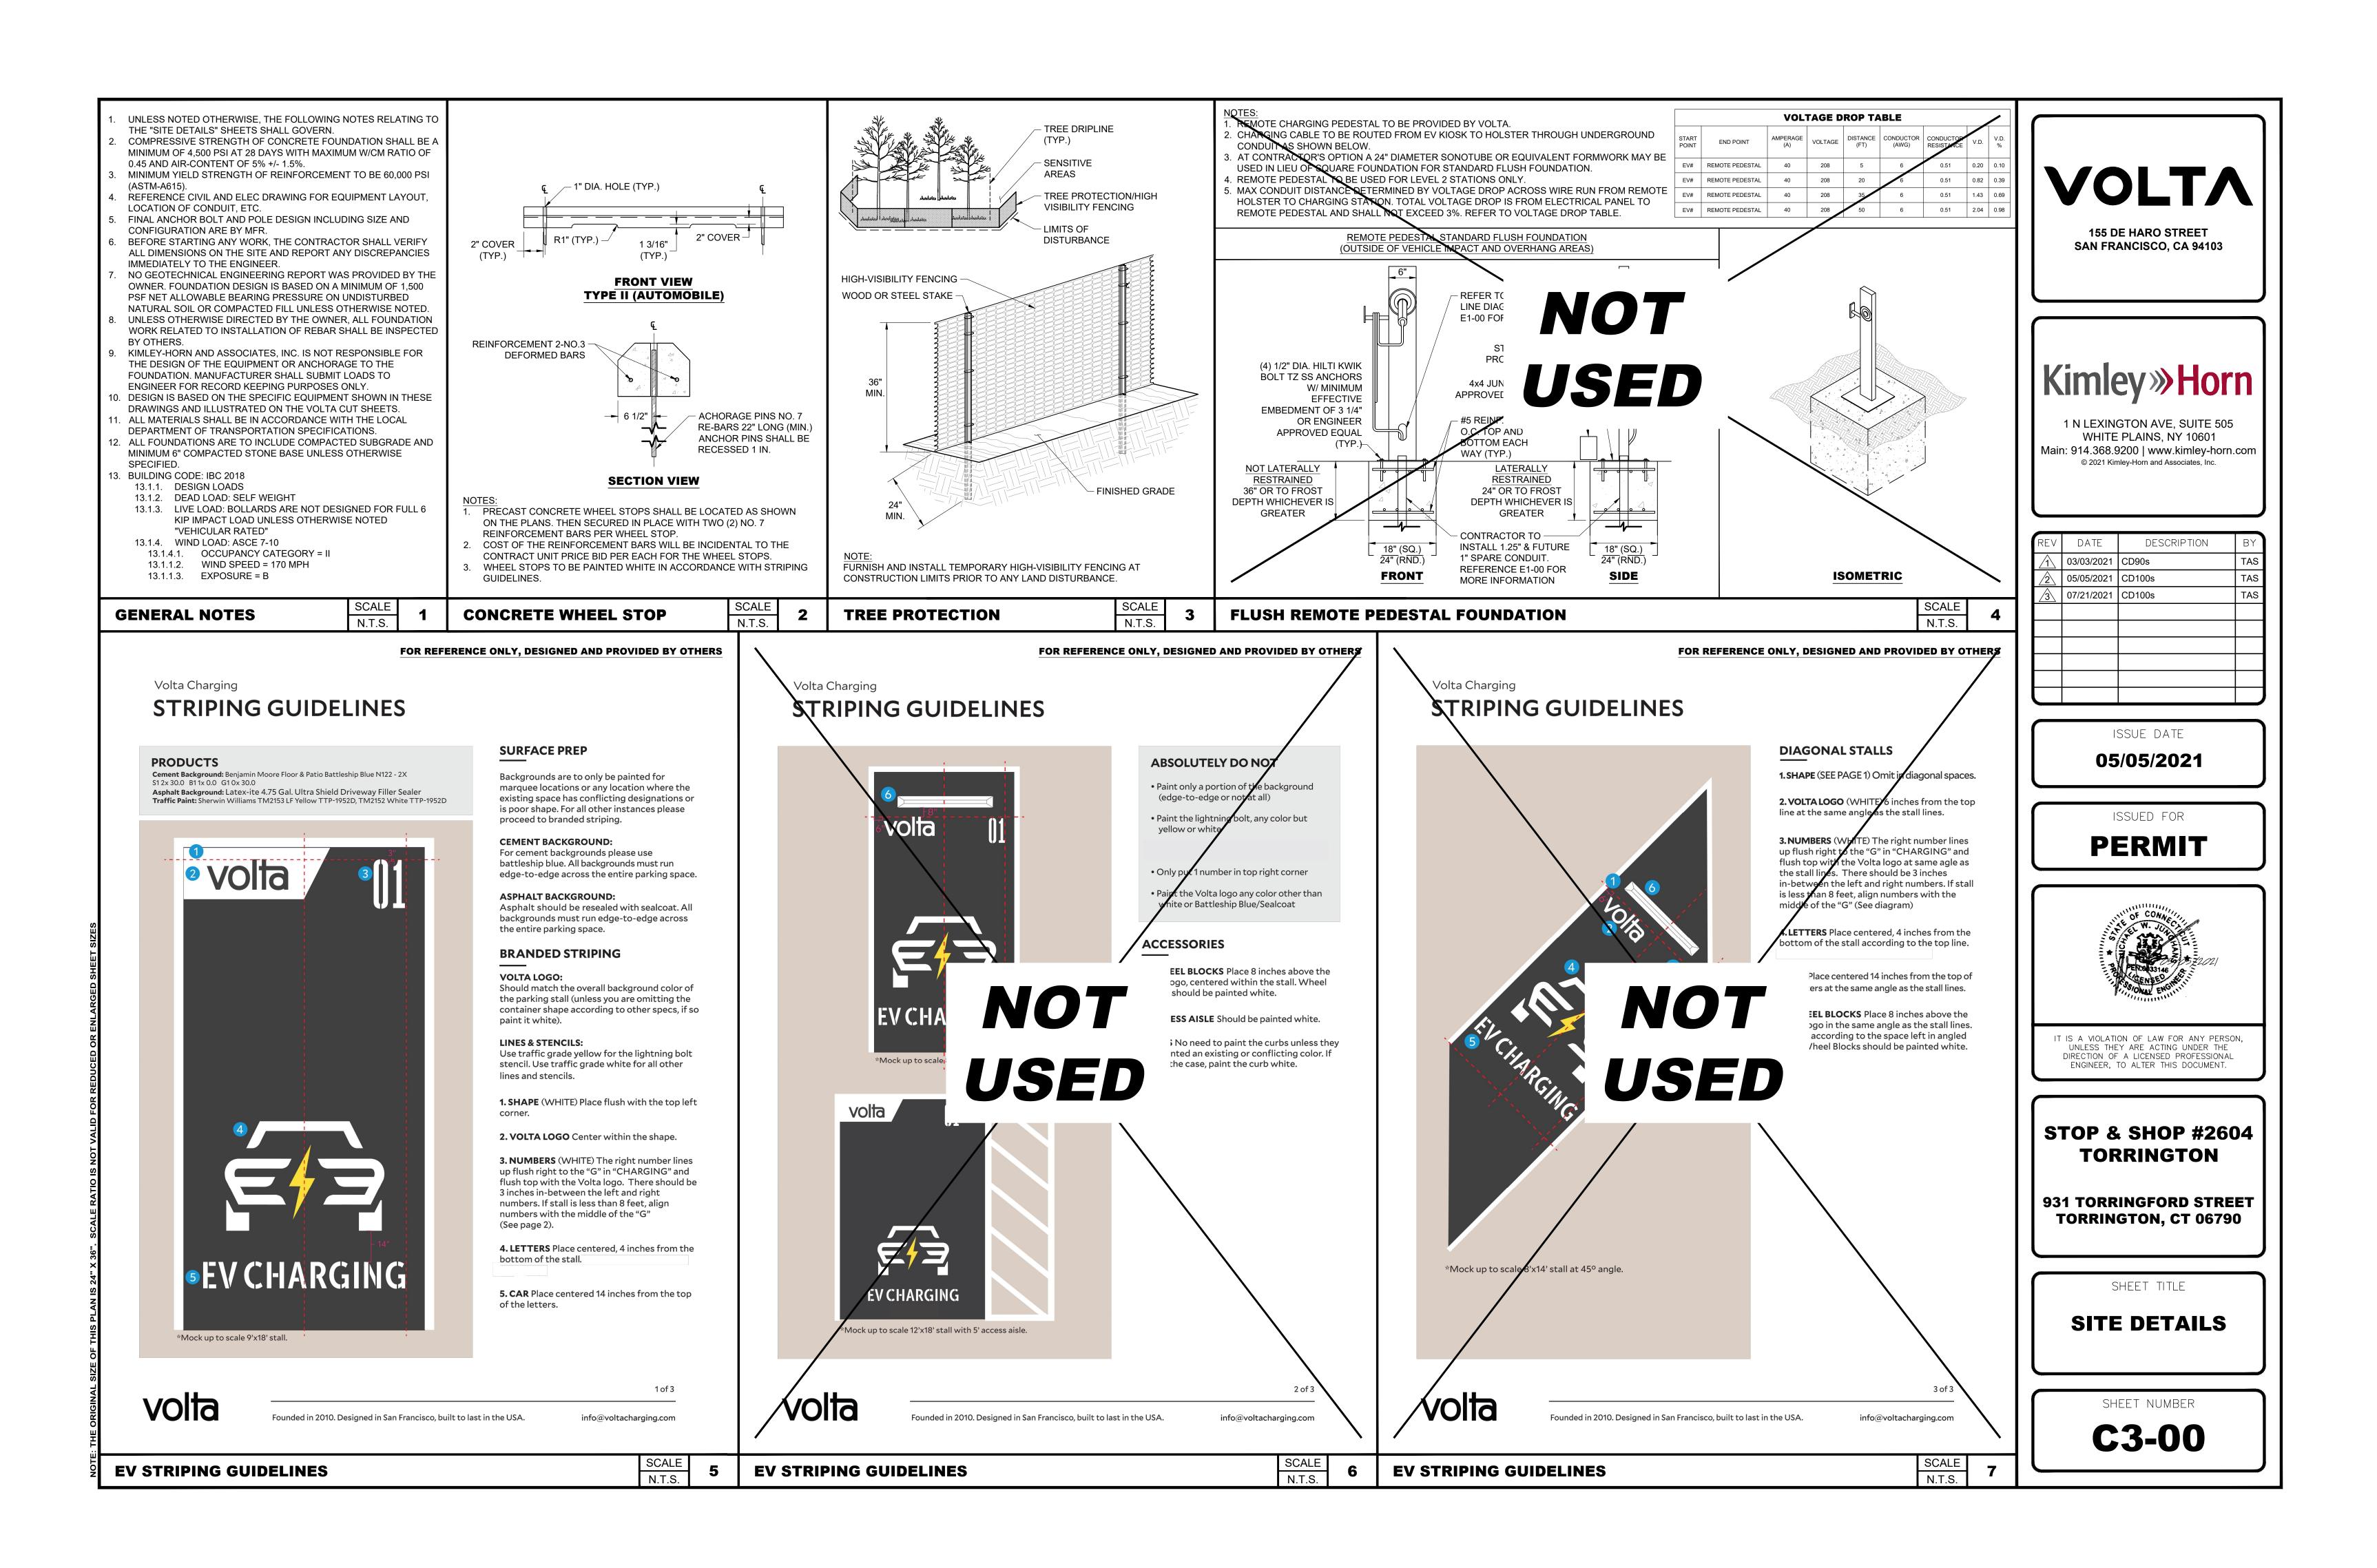

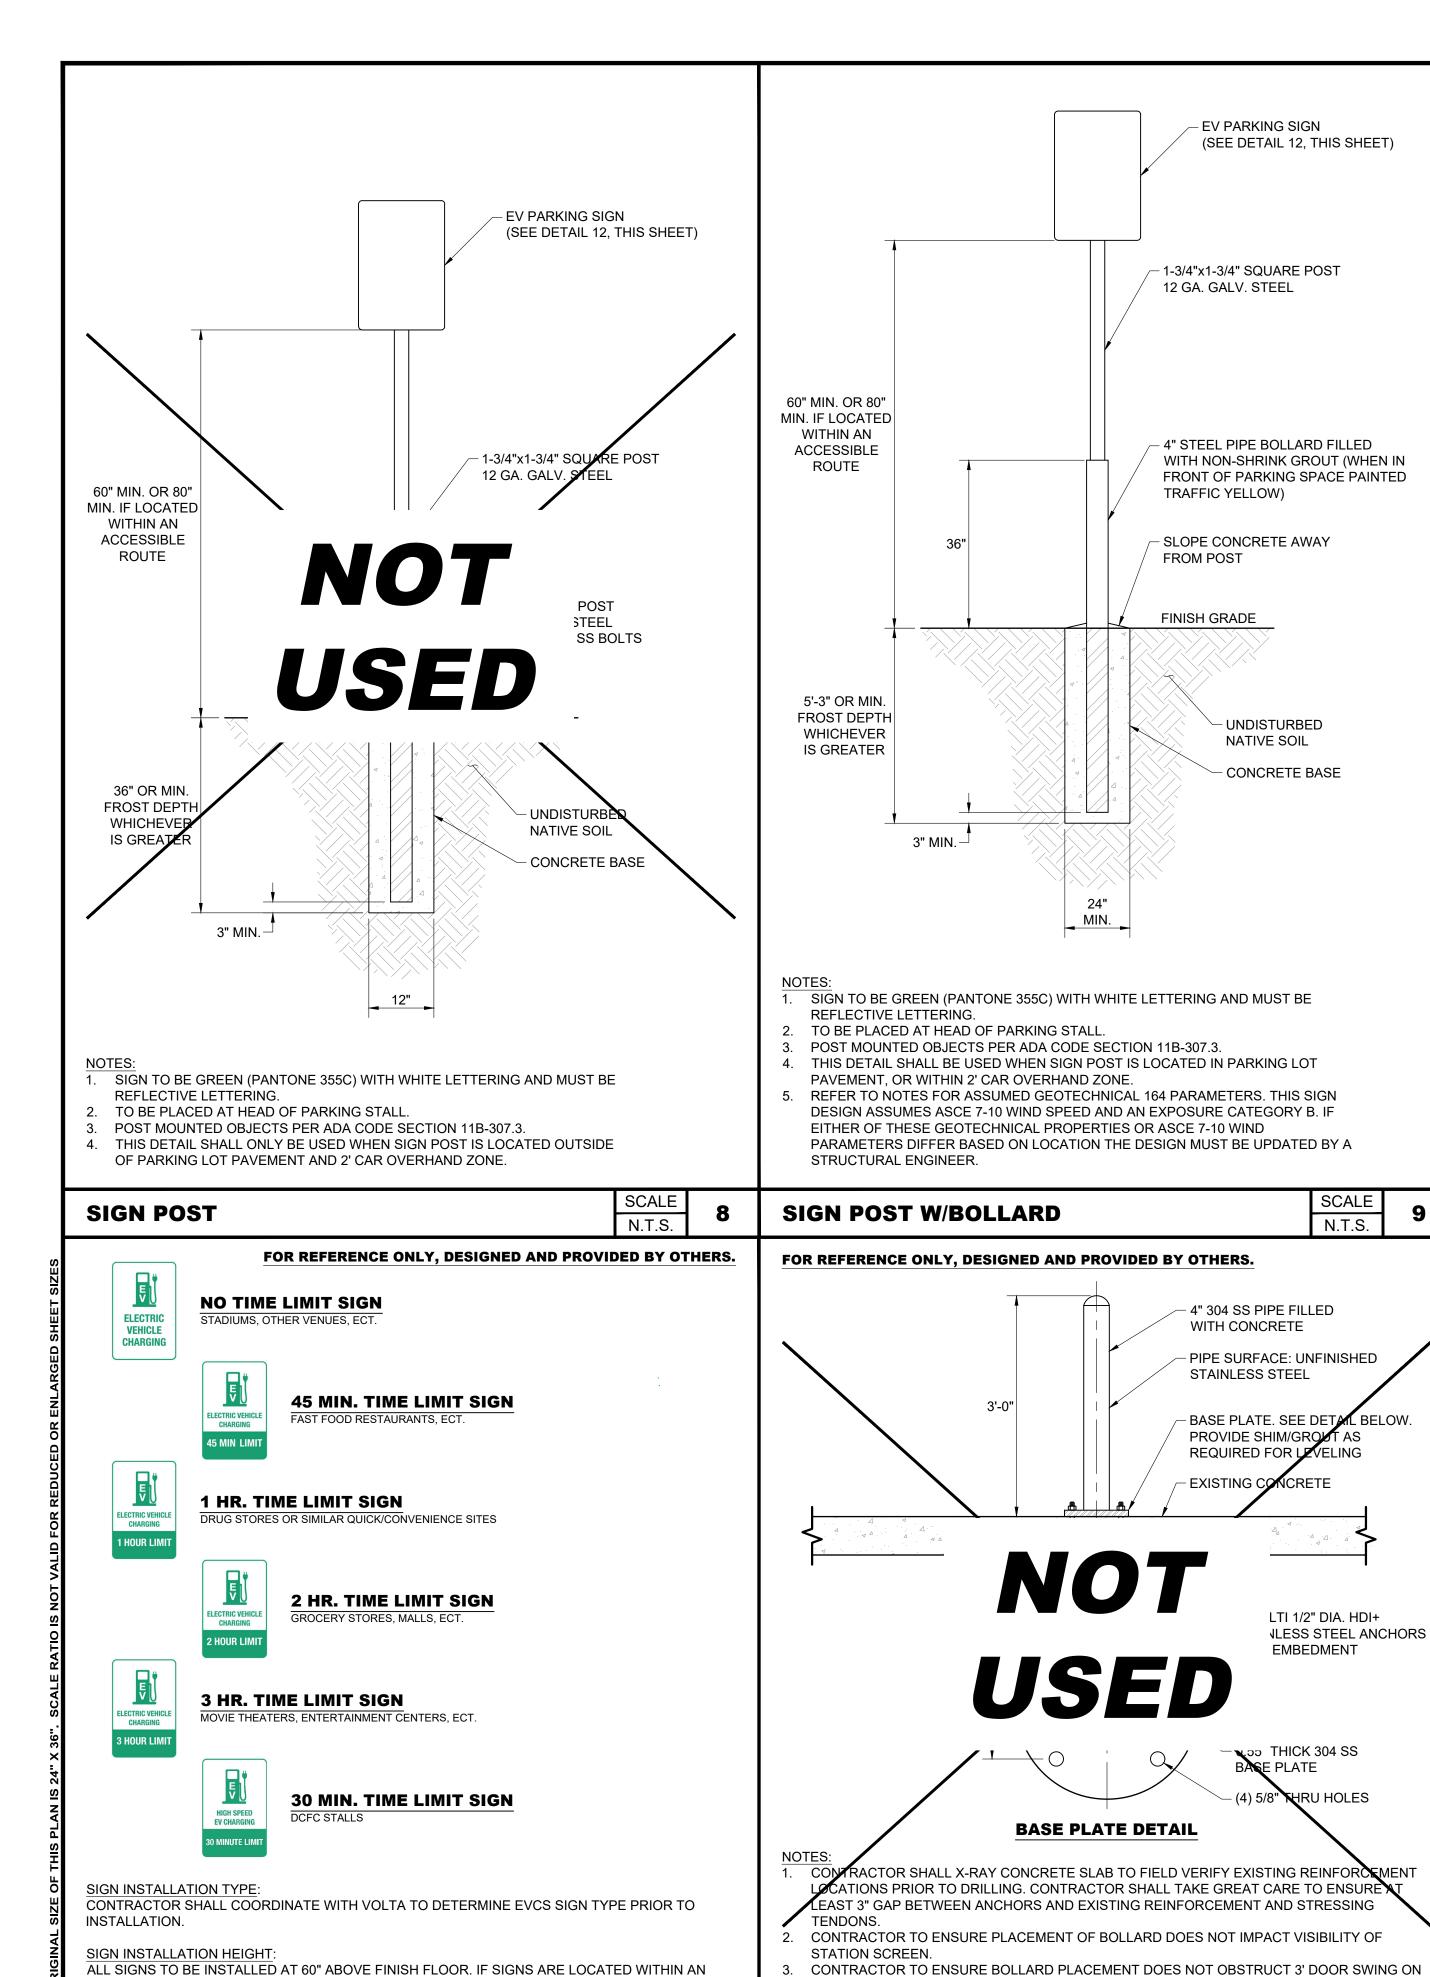


ACCESSIBLE ROUTE, THEY WILL BE INSTALLED AT 80" ABOVE FINISHED FLOOR. MEASUREMENTS

N.T.S.

ARE TAKEN FROM BOTTOM OF LOWEST SIGN.

SIGN REQUIREMENTS

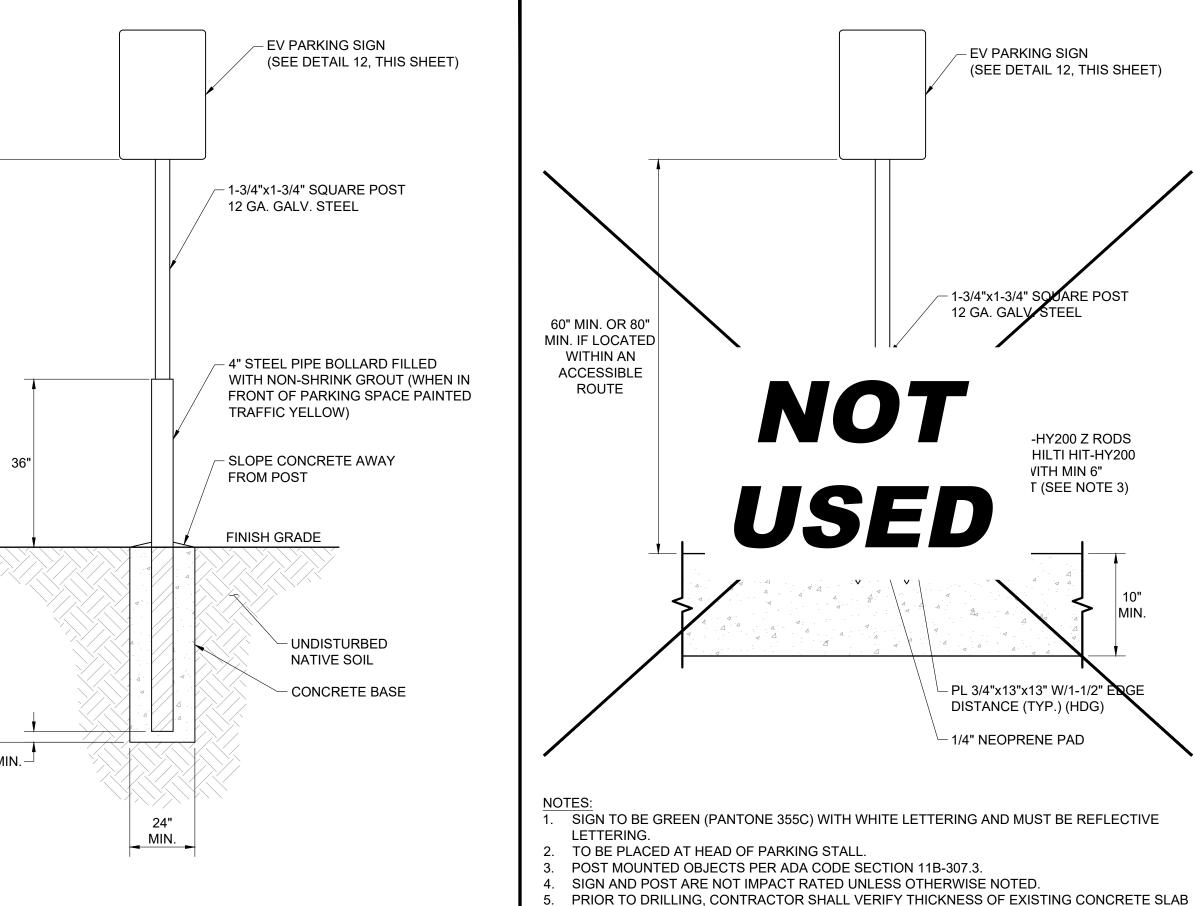

SCALE N.T.S.

4" 304 SS PIPE FILLED

PIPE SURFACE: UNFINISHED

PROVIDE SHIM/GROUT AS

REQUIRED FOR LEVELING

- EXISTING CONCRETE

BASE PLATE. SEE DETAIL BELOW.

LTI 1/2" DIA. HDI+

EMBEDMENT

ູລວ THICK 304 SS

HRU HOLES

N.T.S.

BASE PLATE

BOTH SIDES OF MEDIA STATION.

4. BOLLARDS ARE NOT DESIGNED FOR VEHICULAR IMPACT.

4" DETERRENT BOL. W/ BASE PLATE

ILESS STEEL ANCHORS

WITH CONCRETE

STAINLESS STEEL

– EV PARKING SIGN (SEE DETAIL 12, THIS SHEET) (SEE DETAIL 12, THIS SHEET) - 1-3/4"x1-3/4" SQUARE POST 12 GA. GALV. STEEL 1-3/4"x1-3/4" SQUARE POST 60" MIN. OR 80" - 4" STEEL PIPE BOLLARD FILLED MIN. IF LOCATED SHRINK GROUT (WHEN IN WITHIN AN 'ARKING SPACE PAINTED **ACCESSIBLE** LLOW) ROUTE NOT -HY200 Z RODS -HY200 Z RODS HILTI HIT-HY200 HILTI HIT-HY200 VITH MIN 6" VITH MIN 6" T (SEE NOTE 3) T (SEE NOTE 3) USED MIN. – PL 3/4"x13"x13" W/1-1/2" E**Q**GI - PL 3/4"x13"x13" W/1-1/2" E DISTANCE (TYP.) (HDG) DISTANCE (TYP.) (HDG) 1/4" NEOPRENE PAD

- 1. SIGN TO BE GREEN (PANTONE 355C) WITH WHITE LETTERING AND MUST BE REFLECTIVE

CONCRETE TO BE CURVED -

PIPE SURFACE

2. TO BE PLACED AT HEAD OF PARKING STALL.

POST INSTALLED SIGN POST W/BOL.

- 3. POST MOUNTED OBJECTS PER ADA CODE SECTION 11B-307.3
- 4. SIGN AND POST ARE NOT IMPACT RATED UNLESS OTHERWISE NOTED. PRIOR TO DRILLING, CONTRACTOR SHALL VERIFY THICKNESS OF EXISTING CONCRETE SLAB

IS AT LEAST 10" AND THAT 6" ANCHOR EMBEDMENT CAN BE PROVIDED.

05/05/2021 SCALE N.T.S.

/1\ | 03/03/2021

2 05/05/2021

07/21/2021 | CD100s

ISSUED FOR

ISSUE DATE

VOLTA

155 DE HARO STREET

SAN FRANCISCO, CA 94103


1 N LEXINGTON AVE, SUITE 505

WHITE PLAINS, NY 10601

Main: 914.368.9200 | www.kimley-horn.com © 2021 Kimley-Horn and Associates, Inc.

DESCRIPTION

PERMIT

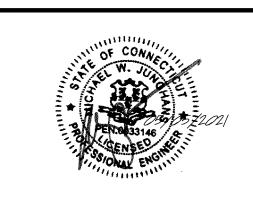

IT IS A VIOLATION OF LAW FOR ANY PERSON, UNLESS THEY ARE ACTING UNDER THE DIRECTION OF A LICENSED PROFESSIONAL ENGINEER, TO ALTER THIS DOCUMENT.

STOP & SHOP #2604 TORRINGTON

931 TORRINGFORD STREET TORRINGTON, CT 06790

SHEET TITLE

SITE DETAILS

C3-01


15

N.T.S.

SHEET NUMBER

FOR REFERENCE ONLY, DESIGNED AND PROVIDED BY OTHERS. FOR REFERENCE ONLY, DESIGNED AND PROVIDED BY OTHERS. 4" 304 SS PIPE

SCALE

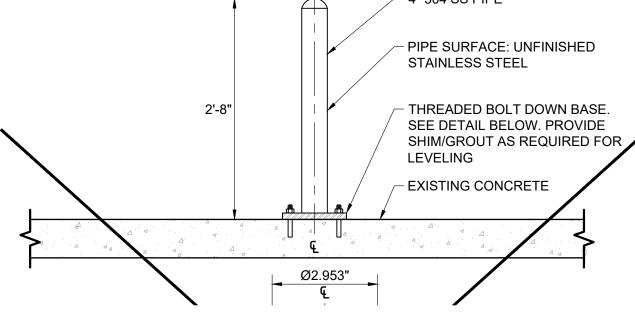

IS AT LEAST 10" AND THAT 6" ANCHOR EMBEDMENT CAN BE PROVIDED.

POST INSTALLED SIGN POST

USED W/ 2" EMBEDMENT


NOT

STAINLESS STEEL ANCHORS (2) 5/8" HOLES THREADED BASE DETAIL

CONTRACTOR SHALL X-RAY CONCRETE SLAB TO FIELD VERIFY EXISTING REINFORCEMENT LOCATIONS PRIOR TO DRILLING. CONTRACTOR SHALL TAKE GREAT CARE TO ENSURE AT LEAST 3" GAP BETWEEN ANCHORS AND EXISTING REINFORCEMENT AND STRESSING

- TENDONS. CONTRACTOR TO ENSURE PLACEMENT OF BOLLARD DOES NOT IMPACT VISIBILITY OF
- STATION SCREEN. CONTRACTOR TO ENSURE BOLLARD PLACEMENT DOES NOT OBSTRUCT 3' DOOR SWING ON
- BOTH SIDES OF MEDIA STATION.
- 4. BOLLARDS ARE NOT DESIGNED FOR VEHICULAR IMPACT.


4" DETERRENT BOL. W/ THREADED BASE

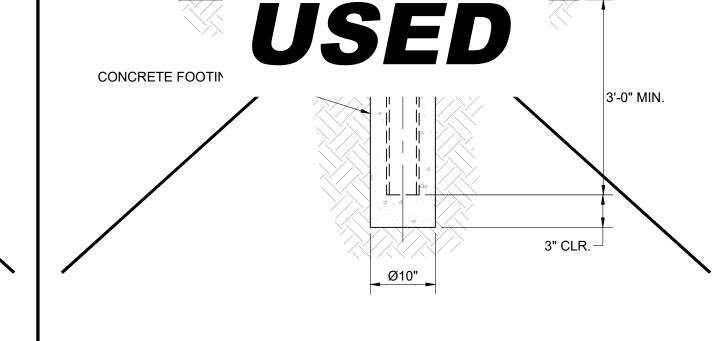



- 1. CONTRACTOR TO ENSURE PLACEMENT OF BOLLARD DOES NOT IMPACT VISIBILITY OF STATION SCREEN.
- 2. CONTRACTOR TO ENSURE BOLLARD PLACEMENT DOES NOT OBSTRUCT 3' DOOR SWING ON BOTH SIDES OF MEDIA STATION.
- 3. BOLLARDS ARE NOT DESIGNED FOR VEHICULAR IMPACT.

4" DETERRENT BOLLARD

SCALE

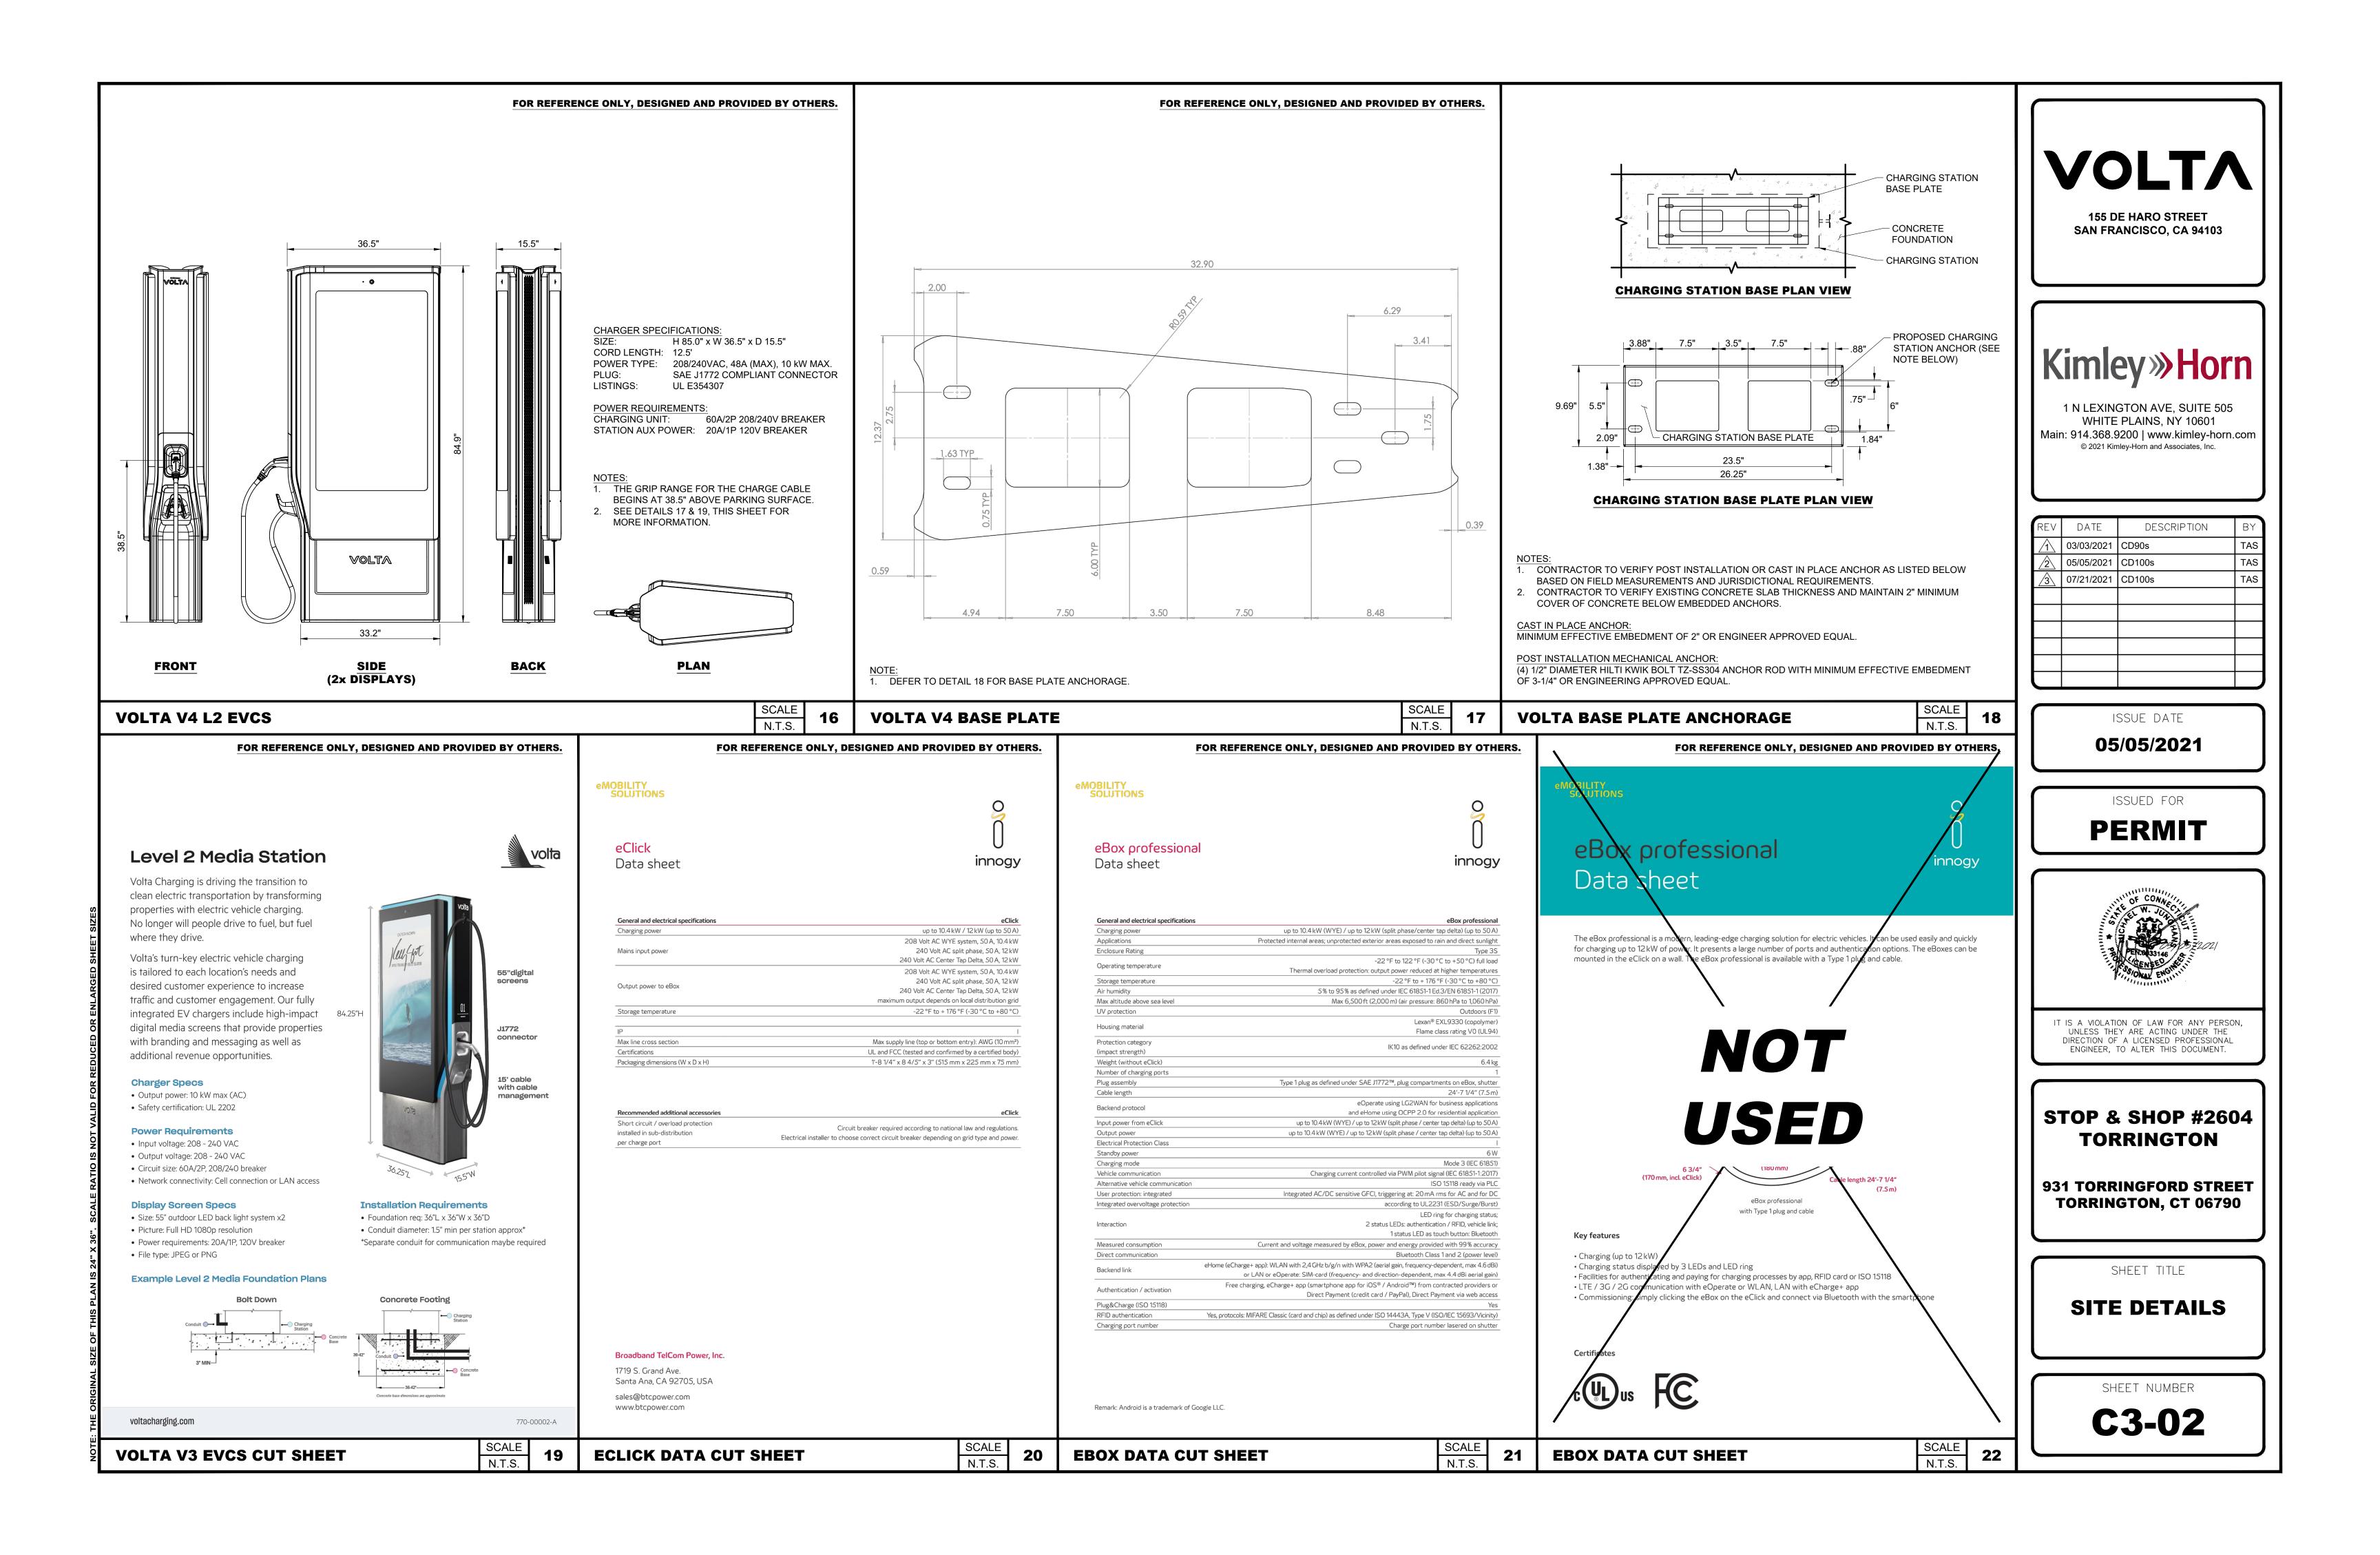

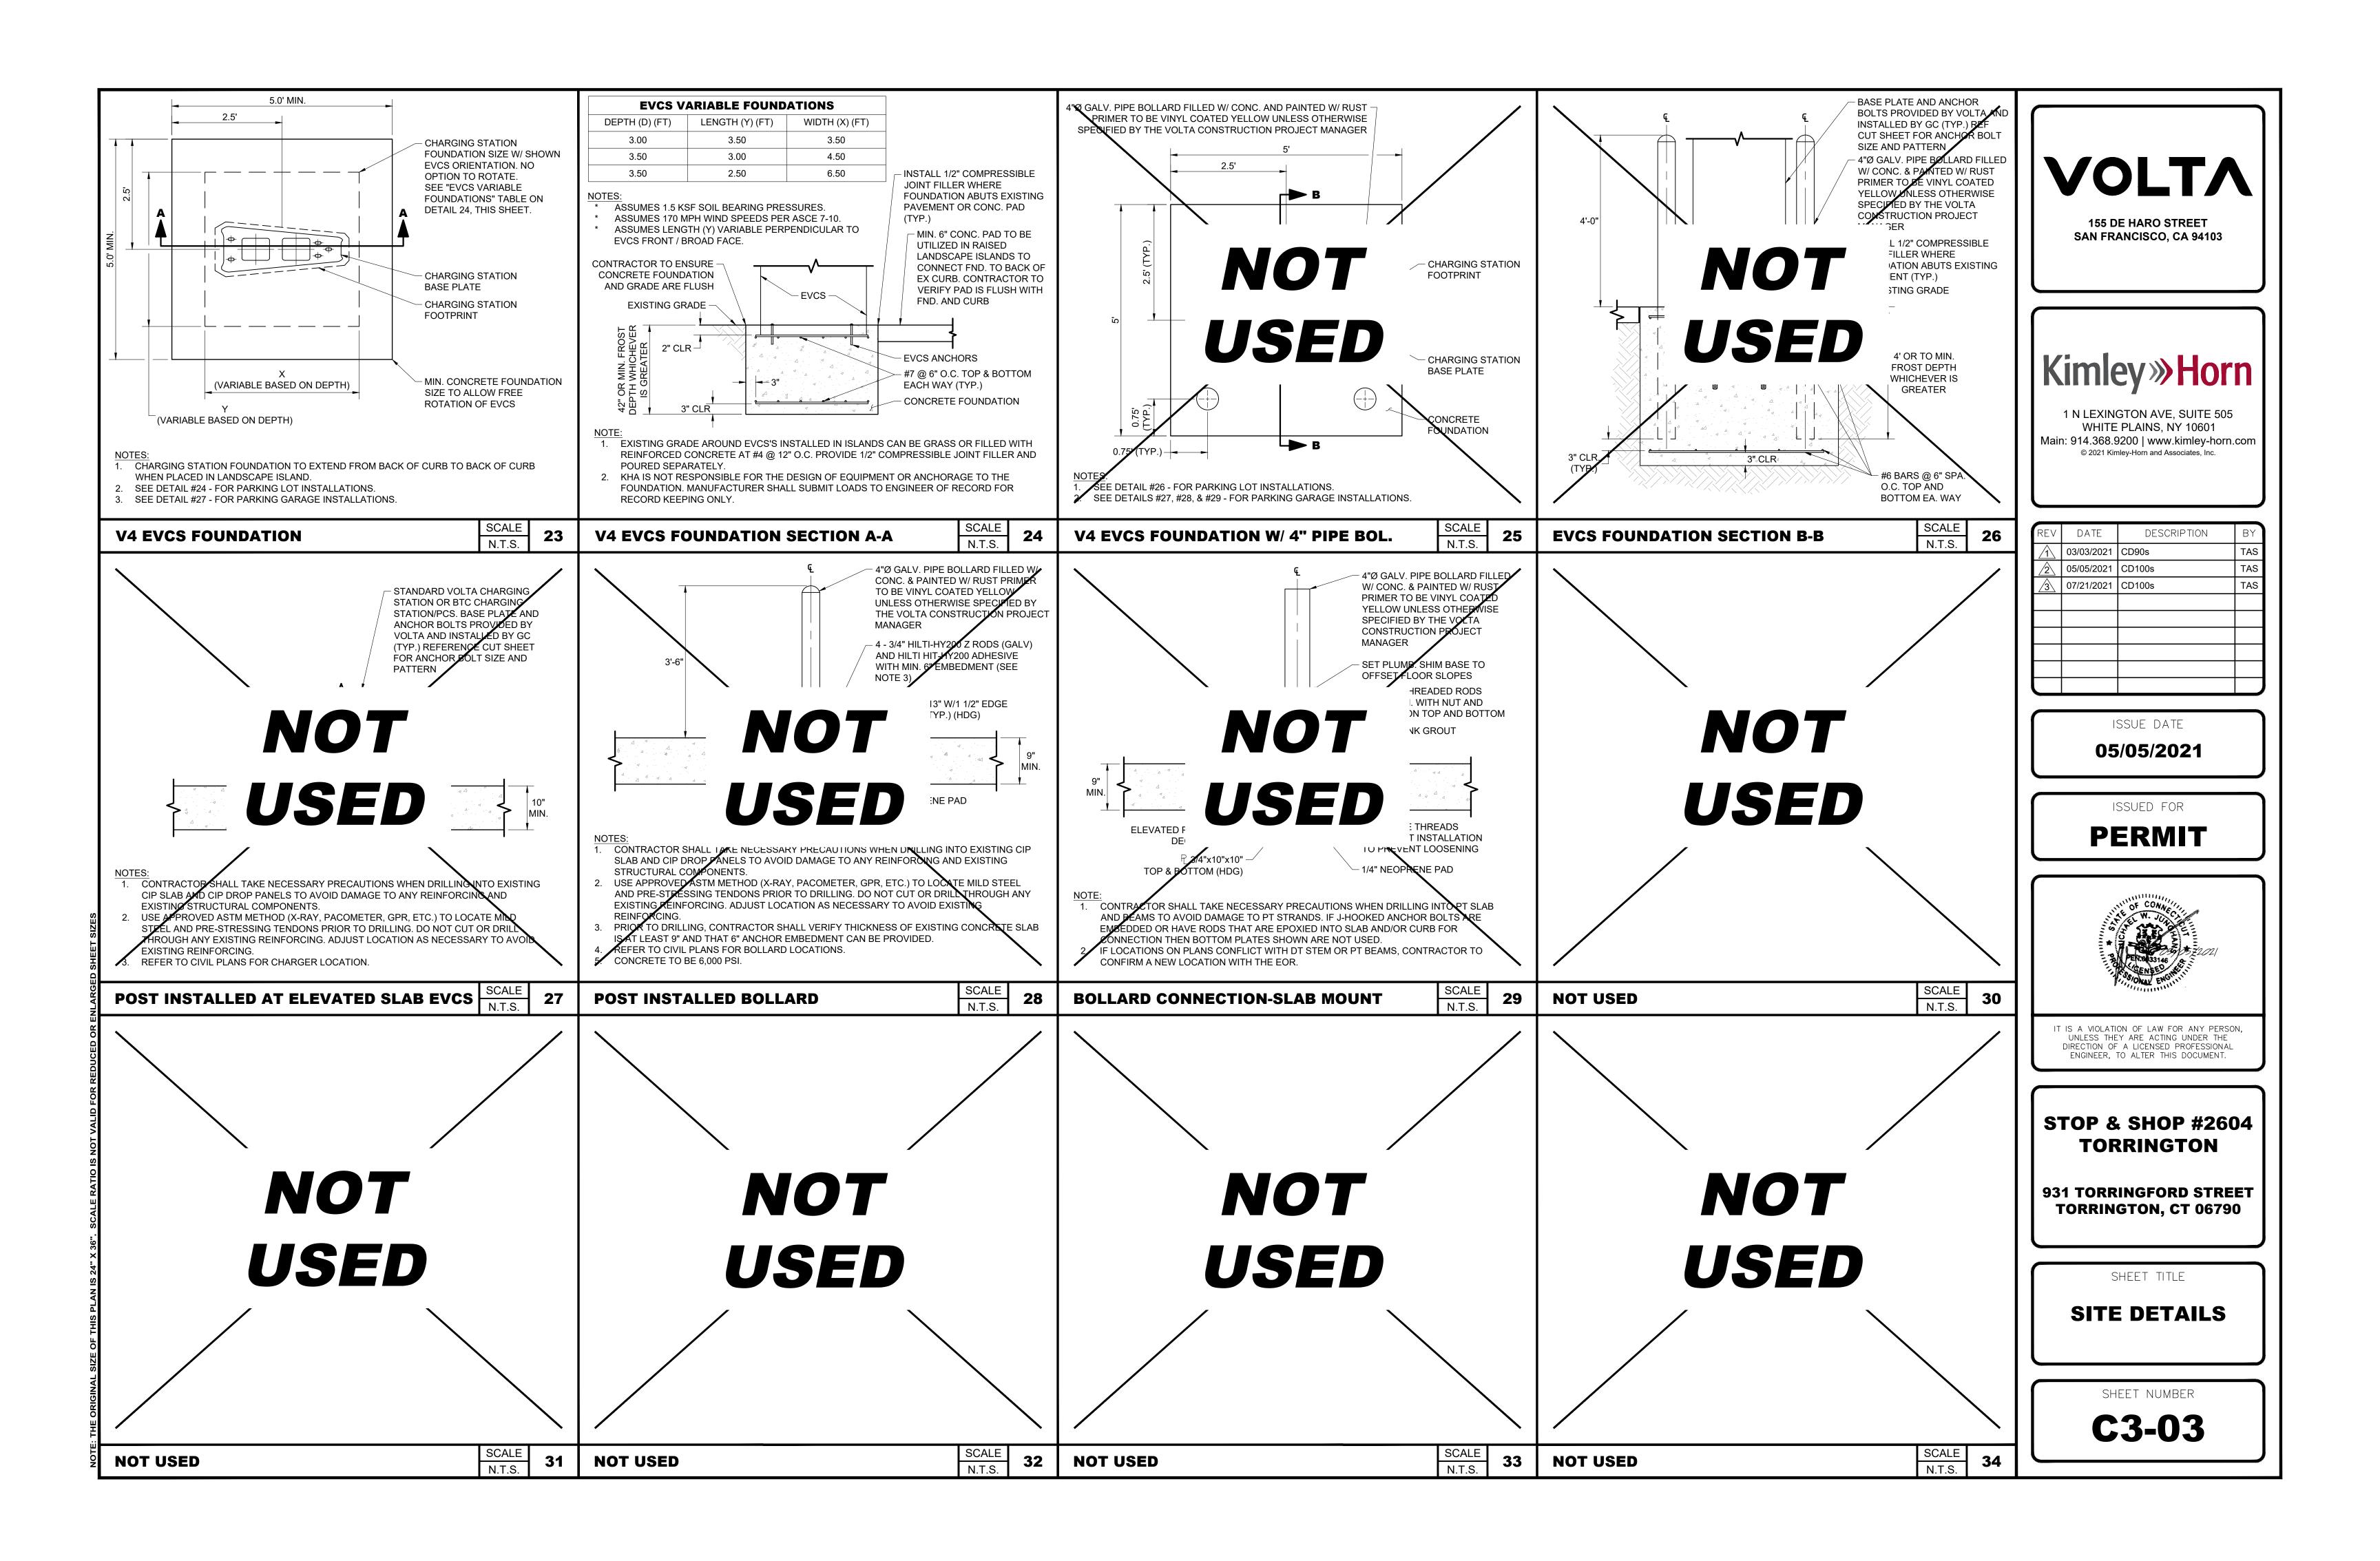

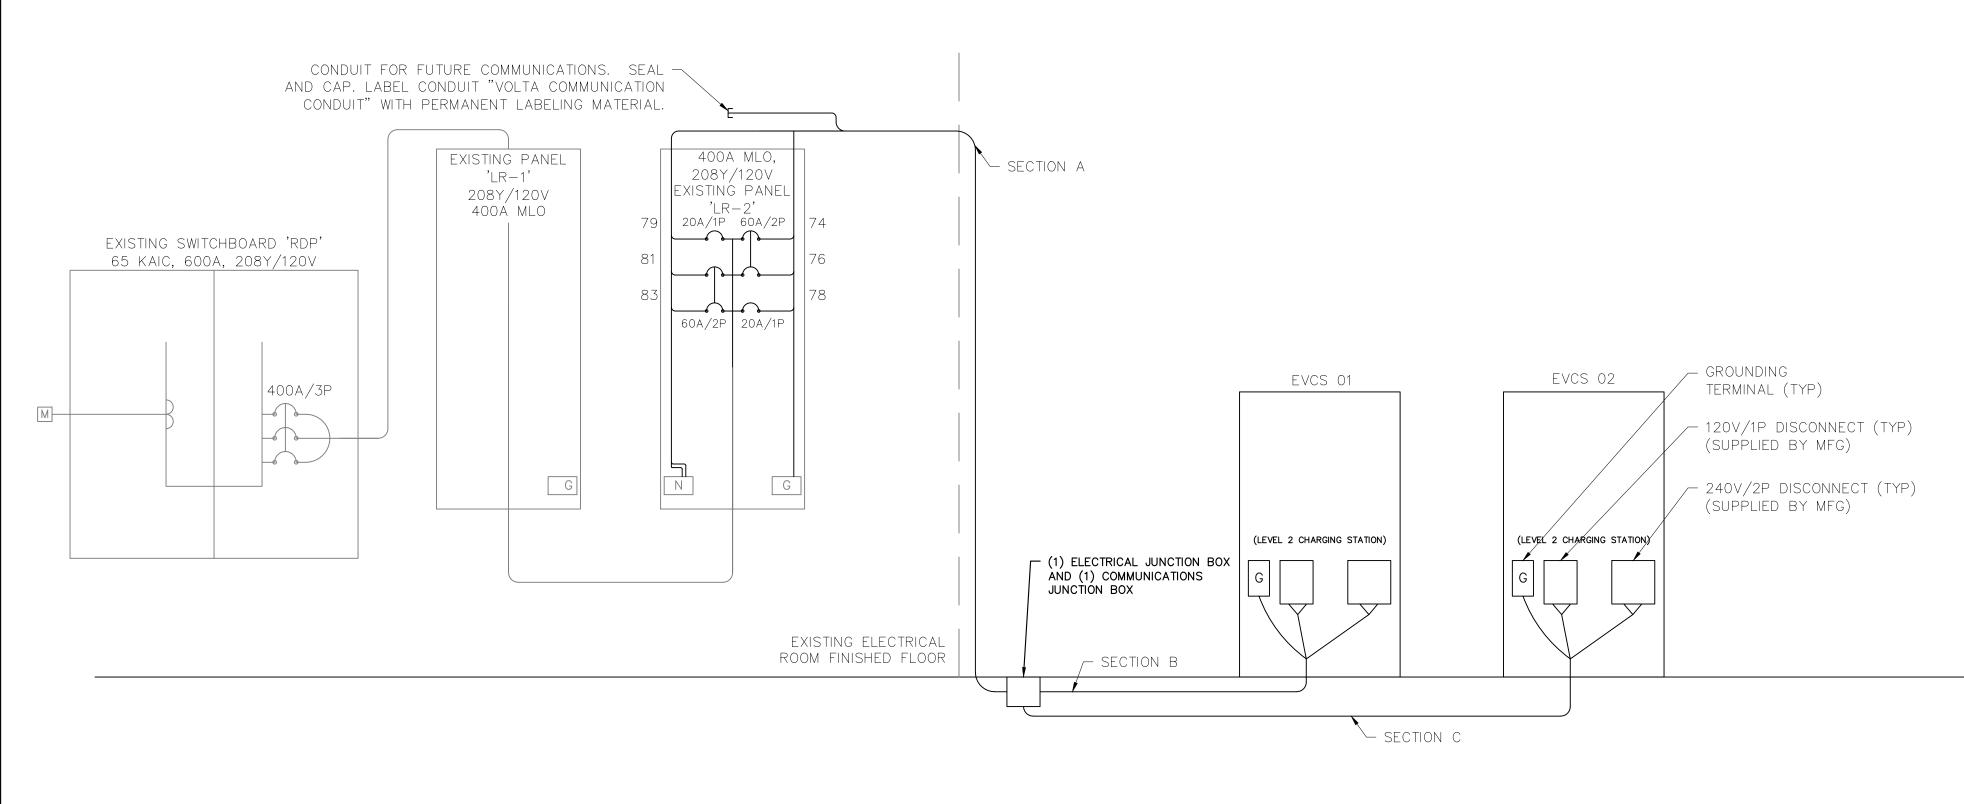



EXISTING ELECTRICAL PANEL 'LR-2'

NOTES:

- 1. ALL ELECTRICAL WORK AND RELATED ACTIVITIES PERFORMED ON SITE SHALL BE DONE IN ACCORDANCE WITH NATIONAL ELECTRICAL CODE (NEC) STANDARDS BEING ENFORCED BY ALL APPLICABLE JURISDICTIONAL REQUIREMENTS AT THE TIME OF CONSTRUCTION.
- 2. ANY PAVEMENT DAMAGED DURING CONSTRUCTION SHALL BE REPAIRED OR REPLACED BY THE CONTRACTOR TO PRE-CONSTRUCTION CONDITIONS OR BETTER.
- 3. CONTRACTOR SHALL USE THWN COPPER CONDUCTORS.
- 4. CONTRACTOR SHALL USE EMT INSIDE AND OUTSIDE ABOVE GRADE WHERE NOT SUBJECT TO DAMAGE. CONTRACTOR SHALL RGS INSIDE AND OUTSIDE ABOVE GRADE WHERE SUBJECT TO DAMAGE. CONTRACTOR SHALL USE PVC SCHEDULE 80 BELOW GRADE.
- 5. SEE SHEETS C1-00 AND C2-00 FOR CONDUIT STUB UP LOCATIONS.
- 6. CONTRACTOR TO LOCATE JUNCTION BOX, CONDUIT PULLING POINT, OR APPROVED ALTERNATIVE FOR SITE SPECIFIC RUN LENGTHS AND BENDS.
- 7. THE CONTRACTOR SHALL PERFORM A 30-DAY LOAD STUDY ON PANEL 'LR-1'/'LR-2' FEEDER BREAKER ON THE SWITCHBOARD. THE LOAD STUDY SHALL UTILIZE A METERING DEVICE THAT CAN MEASURE AND RECORD THE PEAK DEMAND ON EACH PHASE CONDUCTOR AND THE NEUTRAL CONDUCTOR EVERY 15 MINUTES OVER THE DURATION OF THE 30-DAY PERIOD. THE RESULTS SHALL BE SUBMITTED TO THE ENGINEER FOR APPROVAL EITHER IN .XLSX FORMAT WITH DATE, TIME, PHASE COLUMNS AND RECORDED PEAK DEMAND OR IN PLOTTED FORMAT FOR EACH PHASE AND NEUTRAL WITH AMPS SHOWN ON THE Y-AXIS AND TIME ON THE X-AXIS. ON THE RESULTS SUBMITTAL, INCLUDE THE NAME OF THE ELECTRICIAN, THE DAYS THE LOAD STUDY STARTED AND FINISHED, AND THE NAME OF THE PANEL THAT THE LOAD STUDY IS BEING PERFORMED ON. THE CONTRACTOR SHALL NOT PROCEED WITH ANY MODIFICATIONS AND/OR ADDITIONS UNTIL WRITTEN APPROVAL IS RENDERED FROM THE ENGINEER.

							Panel Scl	hedule														
		Ex	isting Panel 'LR	R-2' Loc	ation: Exis	ting Elect	rical Room	Volts: 2	08Y/120	/ Phase	e: 3 Wi	re: 4 Hertz:	60									
			400A ML	O Main	AIC: N/A	Branch	AIC: (See	Note 3)	ENCL. (1	IEMA): 1	MTG:	Surface										
					400 Amp F	rame , G	round Bar,	Locking C	over, Pa	nel Card.												
Description of Load Served	Breaker		Wire		A/Phase		CKT No. CKT No.	CKT NO	A/Phase			Wire	Breaker		Description of Load Served							
Description of Load Served	Amp	Pole	VVIIE	Α	В	С	CKT NO.		Α	В	С	VVIIC	Amp	Pole	Description of Load Served							
				-			43	44	-													
SPACE					-		45	46		-					SPACE							
						-	47	48			-											
				EX			49	50	EX													
SYSTEM DLT19 DEFROST	30	3	EXIST		EX		51	52		EX		EXIST	20	3	SYSTEM DLT12 DEFROST							
						EX	53	54			EX											
SPARE				-			55	56	EX													
SPARE					-		57	58		EX		EXIST	20	3	SYSTEM DLT13 DEFROST							
SPARE						-	59	60			EX	7										
SPARE				-			61	62	EX													
		3			EX		63	64		EX		EXIST	20	3	SYSTEM DLT22 DEFROST							
SYSTEM DLT21 DEFRST	20		EXIST			EX	65	66			EX	7										
				EX			67	68	-						SPACE							
PANEL DLT	20	20								EXIST		EX		69	70		-					SPACE
PANEL DL1	20	2				EX	71	72			-				SPACE							
EVICTING LOAD	20		EXIST	EX			73	74	48.0			See Note 5	60	2	CHARGING STATION EV02							
EXISTING LOAD	20	2	EVIST		EX		75	76		48.0		See Note 5	60	2	CHARGING STATION EVOZ							
SPACE						EX	77	78			5.0	See Note 5	20	1	CHARGING STATION EV02							
CHARGING STATION EV01	20	1	See Note 5	5.0			79	80	EX													
CHARGING STATION EV01	60	2	See Note 5		48.0		81	82		EX		EXIST	20	20 3	DLT20 COND UNIT							
CHARGING STATION EVOT	80		See Note 5			48.0	83	84			EX	7										
	Total A	VPhase		5.0	48.0	48.0			48.0	48.0	5.0		Total A	VPhase								
otes:	1. Connected KVA (New): 24.2																					
	2. Demand	d KVA(Nev	v):	30.3																		
	3. Contrac	tor shall m	natch existing Al	C Rating.																		
	4. Where lo	oad is labe	led "EX" the loa	d is unkno	own.																	
	5. See Volt	age Drop	Table for condu	ctor sizino].																	

L2 Conductor Voltage Drop Table Per Charging Station										
<175FT	175FT-200FT	200FT-255FT	255FT-275FT	275FT-320FT	320FT-400FT	400FT-440FT	440FT-510FT	510FT-635FT	635FT-700FT	700FT-800FT
(2) #4 AWG +	(2) #4 AWG +	(2) #3 AWG +	(2) #2 AWG +	(2) #2 AWG +	(2) #1 AWG +	(2) #1/0 AWG +	(2) #1/0 AWG +	(2) #2/0 AWG +	(2) #3/0 AWG +	(2) #3/0 AWG +
(2) #12 AWG +	(2) #10 AWG +	(2) #10 AWG +	(2) #10 AWG +	(2) #8 AWG +	(2) #8 AWG +	(2) #8 AWG +	(2) #6 AWG +	(2) #6 AWG +	(2) #6 AWG +	(2) #4 AWG +
(1) #6 AWG GND	(1) #6 AWG GND	(1) #4 AWG GND	(1) #3 AWG GND	(1) #3 AWG GND	(1) #2 AWG GND	(1) #1 AWG GND	(1) #1 AWG GND			

VOLTAGE DROP TABLE NOTES

- 1. CONTRACTOR SHALL BE RESPONSIBLE FOR DE-RATING CONDUCTORS WHEN 4 OR MORE CURRENT CARRYING CONDUCTORS ARE CARRIED IN THE SAME CONDUIT PER THE NEC.
- 2. THE DISTANCES IN THIS TABLE ARE TOTAL DISTANCES, NOT HORIZONTAL DISTANCES. INCLUDE VERTICAL RUNS AND JUNCTION BOX COIL LENGTH IN THE TOTAL CONDUCTOR DISTANCE.
- 3. WHEN MORE THAN ONE CHARGING STATION CIRCUIT CONDUCTORS ARE IN A CONDUIT, USE ONLY ONE SHARED EQUIPMENT GROUND CONDUCTOR. 4. WHEN THERE IS A REMOTE HOLSTER, INSTALL (2) #6 AWG + (1) #8 AWG GND + (1) #14 AWG COMM IN THE CONDUIT FROM EVCS TO REMOTE HOLSTER.
- 5. WHEN INSTALLING #1/0 AWG OR LARGER CONDUCTORS FROM THE POWER SOURCE TO EVCS, INCLUDE MULTICONDUCTOR TAPS IN THE CLOSEST JUNCTION BOX PRIOR TO ENTERING THE EVCS OR IN THE EVCS ITSELF SO THAT #6 AWG CONDUCTORS CAN BE TERMINATED IN THE EVCS.

			Conduit Schedule		
Conduit Section	Conduit#	Conduit Size	Conductors	Installation Method	
^	1	2"	(See Voltage Drop Table)	Interior Mount /	
A	2	3/4" Min	Future Communications w/ Pull String	Directional Bore	
В	1	2"	(See Voltage Drop Table)	Diversional Bana	
	2	3/4" Min	Future Communications w/ Pull String	Directional Bore	
С	2"		(See Voltage Drop Table)	Divertional Bour	
	2	3/4" Min	Future Communications w/ Pull String	Directional Bore	



155 DE HARO STREET SAN FRANCISCO, CA 94103



1 N LEXINGTON AVE, SUITE 505 WHITE PLAINS, NY 10601 Main: 914.368.9200 | www.kimley-horn.com © 2021 Kimley-Horn and Associates, Inc.

REV	DATE	DESCRIPTION	ВҮ
1	03/03/2021	CD90s	TAS
2	05/05/2021	CD100s	TAS
3	07/21/2021	CD100s	TAS

ISSUE DATE

05/05/2021

ISSUED FOR

PERMIT



IT IS A VIOLATION OF LAW FOR ANY PERSON, UNLESS THEY ARE ACTING UNDER THE DIRECTION OF A LICENSED PROFESSIONAL ENGINEER, TO ALTER THIS DOCUMENT.

STOP & SHOP #2604 TORRINGTON

931 TORRINGFORD STREET TORRINGTON, CT 06790

SHEET TITLE

ELECTRICAL ONE LINE DIAGRAM & PANEL SCHEDULE

SHEET NUMBER

E1-00

